



DRAWING SCHEDULE

SHEET TITLE

3D VIEW

GENERAL NOTES & DETAILS

А3 FOUNDATION PLAN FLOOR PLATFORM OVER

FOUNDATION

**GROUND FLOOR PLAN** 

SECOND STOREY FLOOR

PLAN

A7 **ROOF PLAN** 

FRONT ELEVATION, DOOR &

WINDOW SCHEDULE Α9 OTHER ELEVATIONS A10 **CROSS SECTION A-A** A11 CROSS SECTION B-B A12 **CROSS SECTION C-C** 

A13 CONSTRUCTION DETAILS

**INTERIOR 3D VIEWS** A14

PROJECT AREA:  GROUND FLOOR: SECOND STOREY: (Less Living (Room Open to Below 492 sqft) TOTAL:	BUILDING AREA 2622 sqft 2034 sqft 4656 sqft	LIVING AREA 2390 sqft 1698 sqft 4088 sqft
FOUNDATION (House): FOUNDATION (GarageC): TOTAL:	3481 sqft 1102 sqft 4583 sqft	
GARAGE (SINGLE): GARAGE (DOUBLE) COVERED ENTRY: ENTRY BETW'N GARAGES: REAR COVERED PORCH: REAR DECK:	343 sqft 714 sqft 186 sqft 30 sqft 460 sqft 150 sqft	

BUILDING AREA (as per National Building Code): the greatest horizontal area of a building above grade within the outside surface of exterior walls or within the outside surface of exterior walls and the centre line of firewalls. Used for cost estimate, building permit & bax

LIVING AREA: area that will be heated or cooled, including floor space under cabinet. bath, shower, staircase opening, fireplace (if not enclosed up to the ceiling) e

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## 1. ARCHITECTURAL DESIGN

It is important to understand that the design and plan which was produced on your behalf by Paragon were designed with a home package-kit structural system. It includes our exclusive wall system which has an R-32 insulation factor. Those plans were also produced with complete structural engineering, mechanical engineering, pre-engineered roof trusses, pre-engineered floor system and a very custom home via and with Paragon home package-kit.

Production of your home package-kit will begin, and we need 6 to 8 weeks to produce all elements included in your home package-kit.

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CONSTRUCTION PROJECT MANAGEMENT BY PARAGON HOMES

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### **CUSTOM ENGINEERED HOME** PACKAGES-KIT BY PARAGON HOMES



P.ENG STAMP FOR DESIGN OF PRIMARY STRUCTURAL ELEMENTS ONLY. JUNE 12, 2020 BY: BLANCHARD LETENDRE ENGINEERING LTD. JOB NO: 20-215

FOR ALL TECHNICAL ISSUE OR QUESTIONS, CONTACT PARAGON HOMES BEFORE CONTINUING THE WORK.

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QUEBEC CONTRACTORS WILL BE HELD LIABLE TO THEIR SPECIFIC SUB-TRADES RESPONSIBILITIES WHEN BUILDING THIS CUSTOM HOME. THE SAME SHALL BE APPLICABLE FOR ONTARIO SUB-TRADES.

DO NOT SCALE THE DRAWINGS.

MATERIAL OR EQUIPMENT.

DATE	DESCRIPTION	REV
2/11/2020	First Preliminary Design Stage	01
2/27/2020	2rd Preliminary Design Stage	02
3/17/2020	3rd Preliminary-Design Stage	03
5/22/2020	Final Plan for General Review	04
5/26/2020	Final Plan for Structural Review	05
6/11/2020	Plan Issued for Building Permit	06
10-27 HOLDON	Car i per i va della valuazione della valuazione	07

PROJECT ADDRESS PROPOSED RESIDENCE for Mr Ercan Indap 43, rue Place Madison Hudson Qc, J0P 1H0 DRAWING TITLE 3D VIEW

PROJECT DIRECTOR FILE NAME N/A FRANK MURRAY PROJECT NUMBER Feb. 2020 AL-20-7 DRAWING NUMBER **A1** of 14

As Shown

### CODES & STANDARDS - DO NOT SCALE THE PLANS. ALL WORKMANSHIP IS TO BE OF A STANDARD EQUAL IN ALL RESPECTS TO GOOD PRACTICE. - AT THE TIME OF PREPARATION, THIS PLAN WAS DRAWN IN ACCORDANCE WITH THE CURRENT EDITION OF THE NATIONAL BUILDING CODE. IT TO INSURE THAT CHANGES TO THE CODE ARE COMPLIED V INCORPORATED IN THE CONSTRUCTION, ALL WORK SHALL CONFORM TO BYLANS ORDINANCES AND REGULATIONS. PRIOR TO PLOCEDING WITH CONSTRUCTION, THE BUILDER MUST VERIFY ALL INFORMATION, DIMENSIONS TAKE PRECEDENCE OVER SCALE MEASUREMENTS. - ANY VARIANCES FROM THE DRAWINGS AND SPECI-THE JOB SITE. SHALL BE RESOLVED BY THE OWNER! BUILDER AND SUCH SOLUTIONS SHALL BE THER SOLE RESP( CONSTRUCTION LOADS ON THE STRUCTURE CAUSED BY INTERIM STORAGE OF MATERIALS SHALL NOT BE ALLOWED TO EXCEED THE DESIGN LOADINGS. THE BUILDER IS TO PROVIDE ALL NECESSARY TEM-PORARY SUPPORT FOR WALLS AND FLOORS PRO TO THE COMPLETION OF VERTICAL AND LATERAL LOAD SYSTEMS THE OWNER BUILDER SHALL BE RESPONSIBLE FOR THE CORRECT SITTING OF THE HOUSE ON THE - The owner Dimensions LOT, LEGAL DESCRIPTION, MORTH DIRECTION, MAIN STREETS AND LOCATIONS OF SERVICES THE OWNER BUILDER TO BE RESPONSIBLE FOR CONDITIONS SUCH AS SOL BLARING CAPACITY. DEPTH OF PROST PENETRATION, WATER TABLE OR BURIED STRUCTURES, ETC. MISCELLANEOUS DOORS & WINDOWS TRAIL FLOOR FINISHES, WANTES. BATH SPLASH AND KITCHEN CABINETS TO MEET SPECIFICATIONS OF OWNER BUILDER - APPROVED LOCKING MEDICINE CABINET TO BE INSTALLED IN AT LEAST ONE BATHROOM. COAT AND CLOTHES CLOSET SHALL HAVE AT LEAST 5 ADJUSTABLE SHELVES WHEREVER POSSIBLE. - CFRAMIC AND PLASTIC THE INSTALLED ON WALLS AROUND BATHTURS OF SHOWERS SHALL BE APPLED OVER MOISTURE RESISTANT BACKING. **GLASS & WINDOWS** GLASS SLIDING PATIO DOORS ARE TO BE OF TEMPERED (\$1.855) ALL WINDOWS SHALL BE AS PER WINDOWS **HEATING & VENTILATION** - BUILDER OR HEATING CONTRACTOR TO PROVICE HEAT LOSS CALCULATIONS AND LAYOUT. THE MECHANICAL & ELECTRICAL DESIGN SHALL BE THE RESPONSIBIL CONTRACTO CONTRACTORS TO ENSURE THAT THERE DISCIPLINE WE'RE DESIGN AND INSTALLED AS PER COOF ELECTRICAL - INSTALLATION OF ELECTRICAL ITEMS MUST COMPLY WITH LOCAL FLECTIONAL CODES AND REGULATIONS IN ALL RESPECTS.

GUIDE ONLY, ADJUST ACCORDING TO OWNERS OR

FAN TO BE OW THERMAL INSULATION 1" (25mm)

THICK AND ANTI-SWEAT VAPOUR BARRIER

IMPORTANT NOTES

CARPENTRY

AND PLUMBING, ETC.

WHEREVER POSSIBLE.

VENTILATION

LOADING

USE OF AREA

ROOF 4408

FRAMING LUMBER SHALL BE NUMBER TWO (2) OR

BETTER UNLESS OTHERWISE SPECIFIED ON PLAN.

AND LINTEL SIZES SHOWN ON THE DRAWINGS ARE

JOIST SHALL BE PLACE TO ACCOMMODATE HEATING

- OWNER/BUILDER TO OBTAIN SHOP CRAWINGS FROM

SHALL BE BRIDGED AT MID SPAN OR KT 7 FT. O.C.

LUMBER FLOOR JST WITH SPANS OF MORE THAN 7 FT.

WITH WOOD. BRIDGING SHALL BE 2/2 DIAGONAL TYPE

FLUSH FRAMED WOOD MEMBERS SHALL BE ANCHORED WITH JOIST HANGERS UNLESS OTHERWISE SPECIFIED.

- DIMENSIONS ARE FROM THE OUTSIDE FACE OF STUDS.

CEILING INSULATION MAY BE LOOSE FILL TYPE OR

WALLS AND CEILINGS BETWEEN RESIDENCE AND

ATTACHED GARAGE SHALL BE INSULATED.

- ALL ROOF SPACES SHALL BE VENTHATED WITH

SOFFIT, ROOF VENTS AND EQUALLY DISTRIBUTED

BETWEEN THE TOP OF ROOF SPACEAND SOFFITS

LIVE LOAD

35 PSF

DEAD LOAD

19 757

14 PSF

- PLATES ARE TO BE ANCHORED TO CONCRETE WITH

1/2" ANCHOR BOLTS @ 72" MAXIMUM/SPACING.

INSULATION & ROOF

AS SHOWN ON ELEVATION DWG.

MAX. UNLESS SHEATING OR STRAPPED BOTH SIDES WITH

BASED ON NUMBER TWO (2) SPRUCE.

MANUFACTURER OF TRUSSES.

#### FLOOR 40 PSF 15 PSF INTERIOR STAIR 40 PSF 10 FSF BALCONY, DECK 40 PSF WALL LATERALLY SUPPORTED AT TOP AS PER 9.15.4.3.(b) FIN GRADE-WITH 2% SLOPE (2)10M REBARS CONTINUOUS MAX. COVER AT TOP C/W 15M "L" BARS (24"x24") IN CORNERS DAMPROOFING SYSTEM No 1 OR EQUIVALENT PLATON MEMBRANE OVER BLUESKIN WATERPROOF MEMBRANE ON AQUABLOC PRIMER (PER MANUF, SPECS) DAMPROOFING SYSTEM No 2 HEAVY COAT OF SPRAYED ON HOT TAR MEMBRANE WITH 24" OF CLEAN SAND AT (2)10M REBARS CONTINUOUS PERIMETER OF FOUNDATION AT BOT, C/W 15M "L" BARS (24"x24") IN CORNERS 4" DIA. PERIMETER DRAN IN 2" (R10) RIGID INSUL. @ A SOX & COVERED/W 6" OF CLEAR CRUSHRUN STONE SLAB PERIMETER RECOMMENDED: IF GARAGE BACKFILL IS -(2)15M REBARS CONTI. FLOODED FOR CONTI. IN FTG. COMPACTION, ENVELOR STONE OVER DRAIN WITH A MIRIAFI FILTER \_ FOR FTG. SIZE INFO. SEE FOUNDATION PLAN OUTLET LOCATIONS IF SHOWN ON PLANS COMPLY WITH CLOTH (DOTTED LINE) DAMPROOFING & REINFORCEMENT BATHROOM FAMS SHALL BE IS CFM AND ALL EXHAUST

P.S.: FOR WALL NOT LATERALLY SUPPORTED AT TOP (Ex: Wall

Around Stair in a Garage or Kneewall on a Found.) See Other Details

TYPICAL FOUNDATION DETAIL SCALE N.T.S.

#### BN3> MOISTURE BARRIER IS REQ'D POURED CONCRETE BETWEEN WOOD & CONCRETE A> CONCRETE WORK SHALL CONFORM TO UNLESS P/T WOOD IS USED. CSA CAN3-A23.1.2.3 WITH MAXIMUM BN4> DBL RIM JSTS SHALL BE AGGREGATE SIZE OF 3/4"(20mm) AND INSTALLED OVER FOUNDATION ULTIMATE STRENGTH AT 28 DAYS OF: WALL PARALLEL TO FLOOR JSTS - 20 Mpa (2900 PSI) WALLS & FTG BN5> HOT WATER TANK SHALL BE - 32 MPa (4650 PSI) GARAGE & EXT. SLAB SECURED TO HOUSE STRUCTURE B> FOR CONCRETE EXPOSED TO CYCLES OF BN6> HEATING & MECHANICAL VENTILATION FROST AND DEFROST, ENTRAINED AIR SYSTEM SHALL BE INSTALLED AS PER MUST BE BETWEEN 4.5 to 7% AND AS CODE AND MANUFACTURER'S SPECS PER CAN3-A266.1 M78 SHALL BE LEFT ON SITE. C> CONCRETE IS TO HAVE A BN7> O.B.C. Sec. 9.9.10.1.(1) EXIT WINDOW MAXIMUM SLUMP OF 100mm (4"). (BASEMENT) Shall be Openable from the D> FOR NORMAL STRUCTURAL CONCRETE Inside Without the Use of Tools and Provides FULL CURING PERIOD IS 28 DAYS. an Individual Unobstructed Open Portion IF FOR ANY REASON, THE CONTRACTOR having a Minimum Area of 0.35m2 with no NEEDS TO DISMANTLE THE FORMWORK Dimensions Less than 380mm. OR APPLY ANY ADDITIONAL LOADS When the Window Opens into a Window Well. BEFORE CURING PERIOD IS OVER a Clearance of 22" (550mm) shall be provided HE MUST GET A WRITTEN CONSENT in Front of Window. FROM A STRUCTURAL ENGINEER. E> NO LIVE LOAD OR DEAD LOAD OTHER THAN THE OWN WEIGHT OF THE CONCRETE ELEMENT SHALL BE APPLIED DURING CURING PERIOD F> CONTRACTOR MUST GIVE ENGINEER 24H. WRITTEN NOTICE BEFORE POURING

BASEMENT NOTES

BE INSTALLED AT THE PERIMETER

OF FTG. AND COVEREDW 6" OF

INSTALLED UNDER BASEMENT

SLAB EXCEPT IF UNDER SLAB IS

INSULATED WITH RIGID INSUL.

BN1> 4"Ø WEEPING TILE IN A SOX TO

CLEAR CRUSHRUN STONE

BN2> 6 MIL VAPOR BARRIER SHALL BE

FOUNDATION NOTES

ALL FOOTING AND PADS MUST BE

CARRIED DOWN TO ELEVATIONS

CAPACITY. ALLOWABLE SOIL

GEOTECHNICAL ENGINEER.

SPECIFIED ON UNDISTURBED SOIL

HAVING 1567 PSF (75 KPa) BEARING

BEARING MUST BE CONFIRMED BY A

50mm (2")

L 127 x 89 x 11

L 127 x 89 x 13

L 152 x 89 x 11

L 152 x 89 x 13

L 152 x 102 x 13

L 178 x 102 x 11

L 178 x 102 x 13

CLEAR SPAN

L5 3.33m

L6 3.54m

L7 3.77m

L8 3.82m

L9 3.99m

L10 4.25m

8'-0" (96")

10'-0" (120")

10'-7" (127")

10'-11" (131")

11'-7" (139")

12'-4" (148")

12'-6" (150")

13'-1" (157")

13'-11" (167")

P.S. STEEL ANGLES SHALL HAVE 6" MIN. BEARING AT BOTH ENDS

SOIL BEARING



TES	FLOOR	PLAN NOTES	<b>ABBREVIATIONS</b>	LEGEND:
BE S DIL ING BY A	STUDS @ 161 WALLS ARE IN UNLESS OTH N2> NAT, GAS F SHALLI BE LE	IOR WALLS ARE IN 2x6 ole AND ALL INTERIOR N 2x4 STUDS @ 16°ole ERWISE SPECIFIED. FIREPLACE MANUF. SPECS IFT ON SITE FOR (IF FIREPLACE IS INSTALLED)	A.A. ATTIC ACCESS ABV ABOVE A.B. ANCHOR BOLT B.F. BI-FOLD BLK: BLOCK BLW: BELOW BW BOTH WAYS B.P. BEAM POCKET 3 1/2" CATH. CATHEDRAL CLG. CEILING	DETAIL OR SECTION NUMBER SHEET NO. WHERE TO FIND I  Electric Smoke & Carbon Monoxide Detector/w Battery Back-up c/w Signaling Device when in Bedoom, all Interconnected with Each Other
TO D F:	N3> INSULATE AND CONTINUE VAPOUR BARRIER WHERE INTERIOR WALLS MEETS WITH EXTERIOR WALLS.  N4> PROVIDE CAULKING AT ALL EXTERIOR WALL FRAMING WHERE FRAMING MEMBERS ABUT.  N5> ALL HOSE BIB SHALL HAVE A BACK FLOW PREVENTER.	BARRIER WHERE INTERIOR WALLS MEETS WITH EXTERIOR WALLS.  SPROVIDE CAULKING AT ALL EXTERIOR WALL FRAMING WHERE FRAMING MEMBERS ABUT.  SPALL HOSE BIB SHALL HAVE A BACK  DISPOSAL DOUBLE JOISTS		Provide Mechanical Exhaust to Outside  Fan - Exhaust to Outside  2x6 Mechanical Wall  W# See WINDOW Schedule on A2  D# See DOOR Schedule on A2
ES OF AIR S	FLUSH MAXIN WALL MEAR T BATH TUB FO	F SHALL BE 6 LITRES PER AUM. ADD BLOCKING IN FOILET, SHOWER AND REFUTUR GRAB BAR AS FEREE DESIGN REQUIRMES.	E.E. EACH END ELEC. ELECTRICAL ELEV. ELEVATION EXT. EXTERIOR EXIST. EXISTING	CARRY ALL POINT LOAD DOWN TO FOUNDATION
ETE CTOR ORK R R L RING PLAN	SHALL NOT E  NB> ALL DOORS HOUSE FROM EQUIPPED W PROVIDE SOL SIDE OF DOO TO RESIST SF  NB> DOOR GIVI TO HOUSE SI COMPLETEM AND WEATHE  N10> ALL OPEN SHALL BE DE PASSAGE OF PREVENT CLI  N11> DIVIDING AND HOUSE SI WITH 1.2" DRI OF WALL AND	N7> HOT WATER SUPPLIED TO FIXTURES SHALL NOT EXCEED 49%ND. (MIXING VALVE)  18> ALL DOORS GIVING DIRECT ACCESS TO HOUSE FROM OUTSIDE SHALL BE EQUIPPED WITH DEADBOLT LOCK. PROVIDE SOLID BLOCKING ON BOTH SIDE OF DOOR JAMBS AT LOCK HEIGHT TO RESIST SPREADING BY FORCE.  19> DOOR GIVING ACCESS FROM GARAGE TO HOUSE SHALL BE METAL INSUL. COMPLETEN SELF CLOSER, DEADBOLT AND WEATHERSTRIP  110> ALL OPENING IN RAILING & GUARDS SHALL BE DESIGNED TO PREVENT THE PASSAGE OF A 4" DIA. SPHERE AND PREVENT CLIMBING.  111> DIVIDING WALL BETWEEN GARAGE AND HOUSE SHALL BE COVERED WITH 1/2" DRYWALL ON BOTH SIDE OF WALL AND DOUBLE TAPE JOINTS IN GARAGE(TYP. FOR WALL & CEILIG).	SHALL NOT EXCEED 49%ND. (MIXING VALVE)  B> ALL DOORS GIVING DIRECT ACCESS TO HOUSE FROM OUTSIDE SHALL BE EQUIPPED WITH DEADBOUT LOCK.  PROVIDE SOLID BLOCKING ON BOTH SIDE OF DOOR JAMBS AT LOCK HEIGHT TO RESIST SPREADING BY FORCE.  BP DOOR GIVING ACCESS FROM GARAGE TO HOUSE SHALL BE METAL INSUL.  COMPLETEW SELF CLOSER, DEADBOLT AND WEATHERSTRIP  AND WEATHERSTRIP  AND WEATHERSTRIP  PASSAGE OF A 4" DIA, SPHERE AND PREVENT CLIMBING.  ITIS DIVIDING WALL BETWEEN GARAGE AND HOUSE SHALL BE COVERED WITH 1/2" DRYWALL ON BOTH SIDE OF WALL AND DOUBLE TAPE JOINTS  MICH CAMBOR CASES FROM GARAGE AND HOUSE SHALL BE COVERED WITH 1/2" DRYWALL ON BOTH SIDE OF WALL AND DOUBLE TAPE JOINTS  MICH CAMBOR CASES TO SUPPORT  GA. GAUGE  GALVANIZED  FL. FLOOR  GALVANIZED  GALVANIZED  GALVANIZED  GALVANIZED  FL. FLOOR  GALVANIZED  FL. FLOOR  GALVANIZED  GALVANIZED  GALVANIZED  GALVANIZED  GALVANIZED  FL. FLOOR  GALVANIZED  GALVANIZED  GALVANIZED  GALVANIZED  FL. FLOOR  GALVANIZED  GALVANIZED  GALVANIZED  GALVANIZED  GALVANIZED  FL. FLOOR  GALVANIZED  GALVANIZED  FL. FLOOR  GALVANIZED  GALVANIZED  FL. FLOOR  GALVANIZED  GALVANIZED  FL. FLOOR  GALVANIZED  GALVANIZED  GALVANIZED  GALVANIZED  FL. FLOOR  GALVANIZED  GALVANIZE  FL. FLOOR  GALVANIZED  GALVANIZED  FL. FLOOR  GALVANIZED  GALVANIZED  GALVANIZED  FL. FLOOR  GALVANIZED  GALVANIZED  FL. FLOOR  GALVANIZED  GALVANIZED  GALVANIZE  FL. FLOOR  GALVANIZE  FL. FLOOR  GALVANIZE  FL. FLOOR  GALVANIZE  FL. FLOOR  GALVANIZE  FL	P1b = BLACKJACK MEDIUM DUTY TYPE 2 JACKPOST T2JPMD P1c = REDJACK HEAVY DUTY TYPE 2 JACKPOST
m (3") m (2") n (2") n (2")	FOR THE FUL AT OPENINGS N13> INCIVIDUA LINTELS SHA WITH A MIN. ( ROW SPACED N14> FRAMER MANUFACTUR IF WOOD I JO N15> RANGE/C	THE FULL STOREY HEIGHT EXCEPT OPENINGS.  INCIVIDUAL MEMBER OF BUILT UP TELS SHALL BE FASTENED TOGETHER THAMIN. OF 3 1/2' NAILS IN A DOUBLE IN SPACED @ 17 3/4" O.C. MAX.  FRAMER TO REFER TO FLOOR JOIST NUFACTURER'S PLAN FOR DETAILS VOCD I JOISTS ARE TO BE USED, RANGE/COOKTOP HOOD & DRYER  MIL. METAL O.H.D. OVER HEAD DOOR PL. POUNDS PER LINEAR FOOT PS.I. POUNDS PER SQUARE INCH PRI. PRESSURE TREATED. PARTITION PRI. POCKET PLYWD. PLYWOOD R.O. ROUGH OPENING S.A. STEEL ANGLE S.B. SOLDIER BRICK		1 King NAILED TOGETHER) P3a = (3)2x6 STUD POST (3 Kings NAILED TOGETHER) P4 = (4)2x6 STUD POST (3 Jack + 1 King NAILED TOGETHER) P4a = (4)2x6 STUD POST (4 Kings NAILED TOGETHER) P5 = 4x4 WOOD POST P/T P6 = 6x6 WOOD POST P/T
L 89 x	SHALL BE EQUIPPED WITH EXHAUST DUCT LEADING TO OUTSIDE.  VENEER (Table 9.20.5.2.B)  EXT. ANGLES FOR 4" BRICK & STONE  89 x 89 x 6.4 L 3 1/2" x 3 1/2" x 1/4"  102 x 89 x 6.4 L 4" x 3 1/2" x 1/4"  127 x 89 x 7.9 L 5" x 3 1/2" x 5/16"		S.C. SOLID CORE S.G.D. SLIDING GLASS DOOR SF SQUARE FOOT SH SINGLE HUNG SL. SIDELIGHT S.S.T. SIMPSON STRONG TIES ST. STIRRLPS STL STEEL SW SWITCH SWC SOLID WOOD CORE TH THICK TO.FD. TOP OF FOUNDATION	P7 = 5 1/4" x 5 1/4" VERSA-LAM P8 = 6x8 PINE TIMBER POST If Header is NOT Tight Under Top Plates, Solid Blocking to Match Support shall be Installed at Ends.

TO FD. TOP OF FOUNDATION TO FTG. TOP OF FOOTING

T.O.PL. TOP OF WOOD PLATE

UNDERSIDE

VERT. VERTICAL

TRIPLE JOISTS TYPICAL

WATER CLOSET

HEADER LEGEND:

All Header To Be (2)2x10 with P2


UNLESS OTHERWISE NOTED.

H1 =(2)2x12 H4 =(2)2x10 H7 =(2)2x8

H2 =(3)2x12 H5 =(3)2x10 H8 =(3)2x8

H3 =(4)2x12 H6 =(4)2x10 H9 =(4)2x8

H10=(2)2x6 H11=(3)2x6 H12=(4)2x6

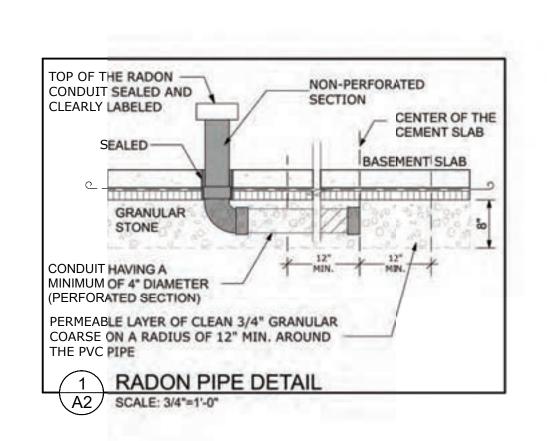

on Plan)



L5" x 3 1/2" x 7/16"

L5' x 3 1/2' x 1/2"

L6" x 3 1/2" x 7/16"

L6"x31/2"x1/2"

L6" x 4" x 1/2"

L7" x 4" x 7/16"

L7" x 4" x 1/2"



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LEGEND



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Non-post non-	Name and Address of the Parties of t	07

A.L. F.M

PROJECT ADDRESS PROPOSED RESIDENCE for Mr Ercan Indap 43, rue Place Madison Hudson Qc, J0P 1H0 DRAWING TITLE

GENERALE NOTES & DETAILS

FILE NAME

N/A FRANK MURRAY PROJECT NUMBER Feb. 2020 AL-20-7 DRAWING NUMBER A2 of 14 As Shown

PROJECT DIRECTOR

WOOD POST/STEEL COL. LEGEND When NOT SPECIFIED, Standard Support (BOTH END) of Header Above Openings in Load Bearing

Stud Wall is 1 JACK and 1 KING. P1 = 3"dia. STEEL TELEPOST ANCHORED AT TOP & BOT.

P1a = REDJACK LIGHT DUTY TYPE 2 JACKPOST T2JPLD P1b = BLACKJACK MEDIUM DUTY

TYPE 2 JACKPOST P1c = REDJACK HEAVY DUTY

TYPE 2 JACKPOST T2JPHD

P1d = 4" x 4" x 1/4" HSS c/w 10"x8"x1/2" Top & Bottom Plate P2 = (2)2x6 STUD POST (1 Jack + 1 King NAILED TOGETHER)

P2a = (2)2x6 STUD POST(2 Kings NAILED TOGETHER)

P3 = (3)2x6 STUD POST (2 Jack + 1 King NAILED TOGETHER) P3a = (3)2x6 STUD POST (3 Kings NAILED TOGETHER)

P4 = (4)2x6 STUD POST (3 Jack + 1 King NAILED TOGETHER) P4a = (4)2x6 STUD POST

(4 Kings NAILED TOGETHER) P5 = 4x4 WOOD POST P/T

P6 = 6x6 WOOD POST P/T \* = From Conc Pilar To Roof Beam P7 = 5 1/4" x 5 1/4" VERSA-LAM

If Header is NOT Tight Under Top Plates, Solid Blocking to Match Support shall be installed at Ends.


CONC. FOOTING EXCEPT OTHERWISE SHOWN ON PLAN, FOOTING ARE:

> UNDER 8" WALL: 24"x8" UNDER 10" WALL: 26"x8" UNDER 12" WALL: 28"x8"

ALL FOOTING REINF'D WITH (2)15M REBARS CONTINUOUS C/W "L" BARS IN CORNERS.

FOUNDATION WALL: ALL are POURED CONC. REINF'D WITH (2)10M REBARS AT TOP & (2)15M REBARS AT BOTTOM OF WALL.

WINDOW OPENINGS IN FOUNDATION: FOUNDATION AROUND WINDOW OPENINGS LARGER THAN 47 1/2" SHALL BE REINFORCED SEE DETAIL 1/A3 & ELEVATIONS

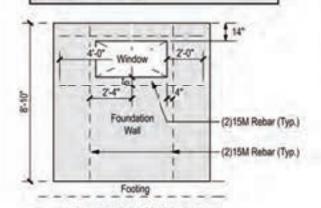

FOUNDATION WALL

REINFORCEMENT

(CP) CONCRETE PAD

CP1 = 24" x 24" x 8" c/w (2)15m "L" Dowels (10"x32") when Supporting Concrete Pilar

CP2 = 36" x 36" x 8" c/w (3)15m

CP3 = 60" x 60" x 8" c/w (7)15m Both Ways CP4 = 66" x 66" x 8" c/w (8)15m

Both Ways

(S) SONOTUBE/PLAR

\$1 = 9" x 9" x 66" High Concrete Pilar Reinfd/w (2)15M Rebars

Elevation Marker Height of Top

SEE FOUNDATION & BASM'T RELATED NOTES ON A2

LEGEND:

A DETAIL OR SECTION NUMBER SHEET NO. WHERE TO FIND IT

Electric Smoke & Carbon Monoxide Detector/w Battery Back-up c/w Signaling Device when in Bedoom, all Interconnected with Each Other

Provide Mechanical Exhaust to

Fan - Exhaust to Outside 2x6 Mechanical Wall

WW See WINDOW Schedule on A1 D# See DOOR Schedule on A1

LVL = LAMINATED VENEER LUMBER F/LVL = FLUSH LAMINATED VENEER LUMBER ALL TO BE DESIGNED BY MANUFACTURER

of Footing, Top Wall, Wall

BACKFILL NOTE:

1> CLEAN SAND BACKFILL UNDER

2> CLEAN SAND BACKFILL.

COMPACTION NOT REQ'D.

GARAGE SLAB SHALL BE COMPACTED

WITH VIBRATING PLATE AT EVERY 12"

ALL SPECIFIED LVL TO BE 2900Fb-2.0E

CARRY ALL POINT LOAD DOWN TO FOOTING & FOUNDATION ...

STEEL ANGLE:

L# = See steel Angle Table on A2

**CUSTOM ENGINEERED HOME** PACKAGES-KIT BY PARAGON HOMES

MAISONS

710-1180 Chemin d'Aylmer

Gatineau, Qc., J9H 0G5

OFFICE: (Qc) 1-819-503-6820

CEL: 819-743-9220

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CONSTRUCTION PROJECT MANAGEMENT

BY PARAGON HOMES

(On) 1-613-789-0220

PARAGON

HOMES

LEGEND



ENG STAMP FOR DESIGN OF PRIMARY STRUCTURAL ELEMENTS ONLY. JUNE 12, 2020

FOR ALL TECHNICAL ISSUE OR QUESTIONS, CONTACT PARAGON HOMES BEFORE CONTINUING THE WORK.

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- BY RULES OF THE ART. IF THERE IS A PLACE IN ACCORDANCE WITH THE RECOMMENDATIONS OF THE MANUFACTURERS OF THE MATERIAL OR EQUIPMENT.

QUEBEC CONTRACTORS WILL BE HELD LIABLE TO THEIR SPECIFIC SUB-TRADES RESPONSIBILITIES WHEN BUILDING THIS CUSTOM HOME. THE SAME SHALL BE APPLICABLE FOR ONTARIO SUB-TRADES.

DO NOT SCALE THE DRAWINGS.

DATE m/d/y	DESCRIPTION	REV
	First Preliminary Design Stage	01
	2nd Preliminary Design Stage	02
3/17/2020	3rd Preliminary-Design Stage	03
	Final Plan for General Review	04
	Final Plan for Structural Review	05
ALC: 10.00 PM TO THE TOTAL PROPERTY OF THE T	Plan Issued for Building Permit	06
THE PROPERTY.	HOLD STREET, S	07

A.L.

PROJECT ADDRESS PROPOSED RESIDENCE for Mr Ercan Indap 43, rue Place Madison Hudson Qc, J0P 1H0 **DRAWING TITLE** 


FOUNDATION PLAN


Feb. 2020 DRAWING NUMBER A3 of 14

FILE NAME N/A

DATE

PROJECT DIRECTOR FRANK MURRAY PROJECT NUMBER AL-20-7 SCALE As Shown

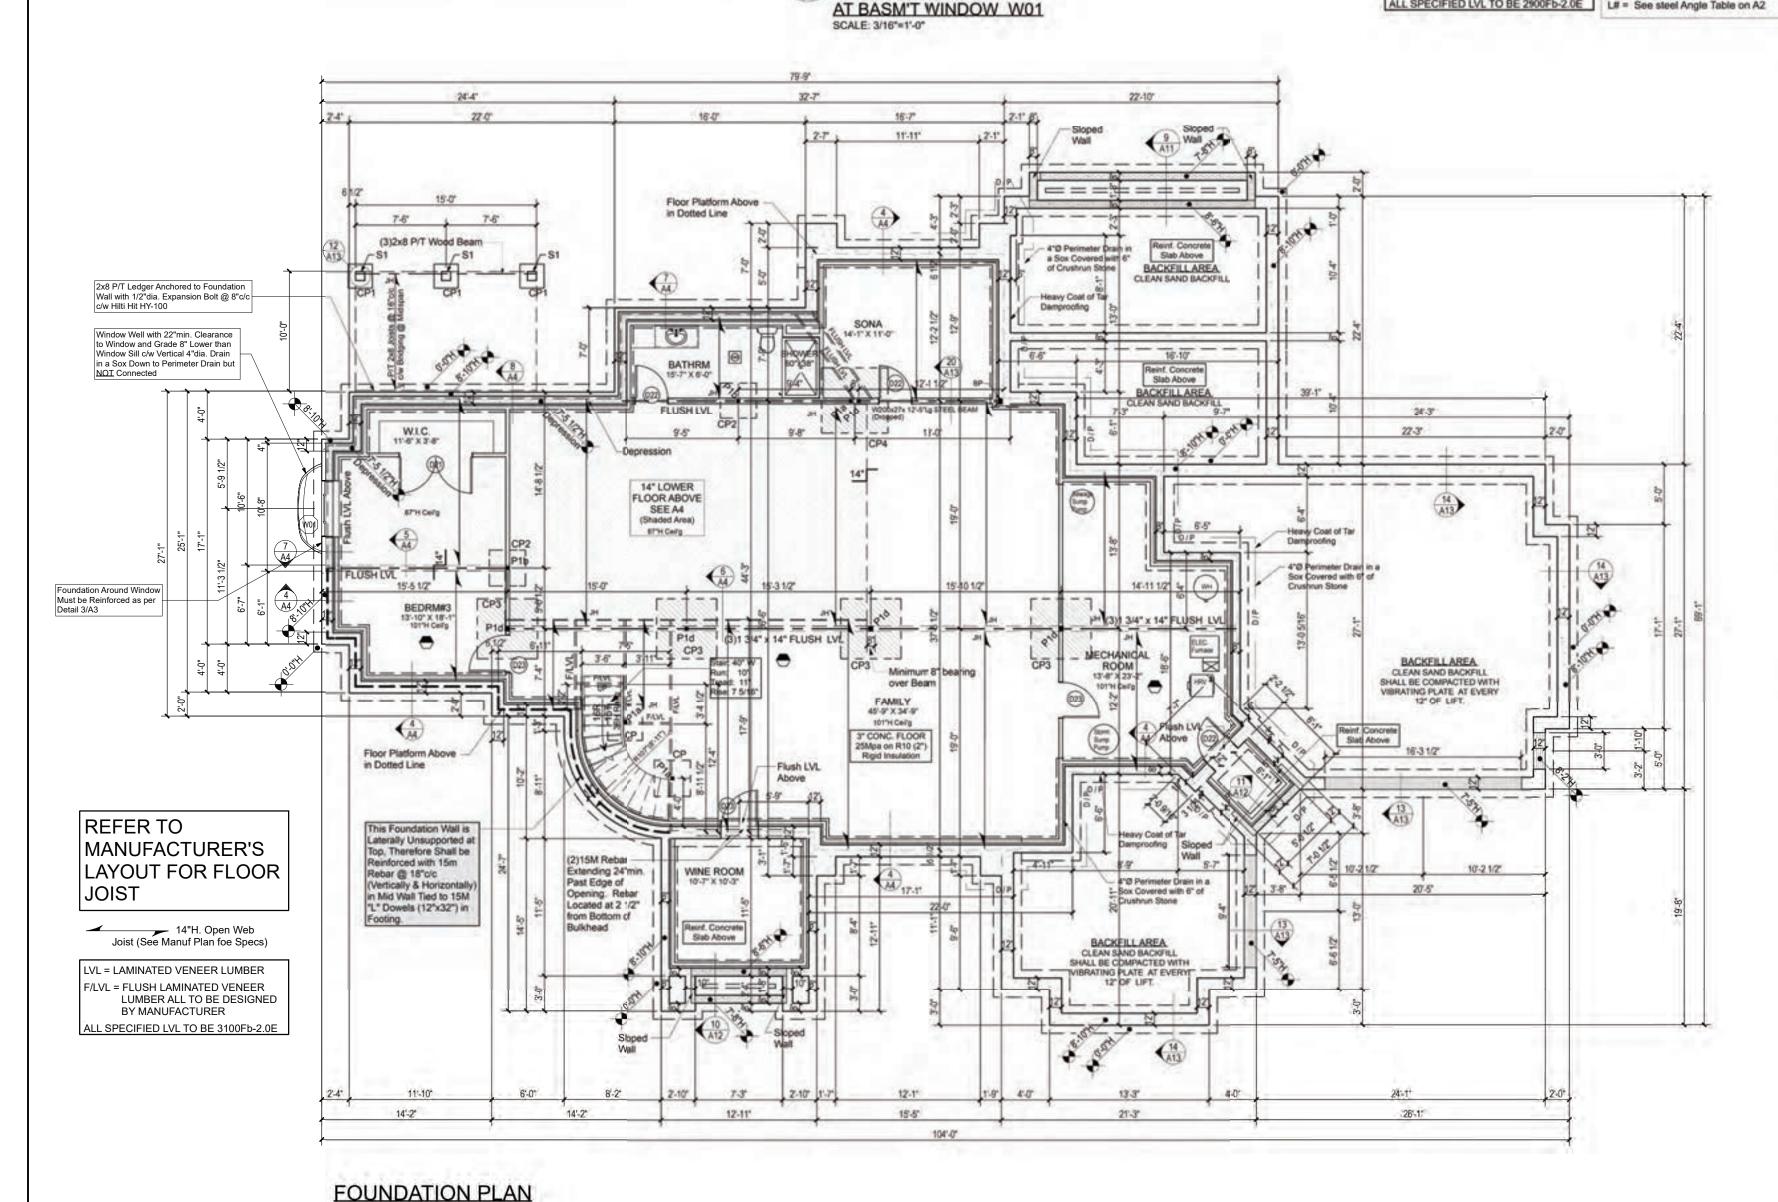

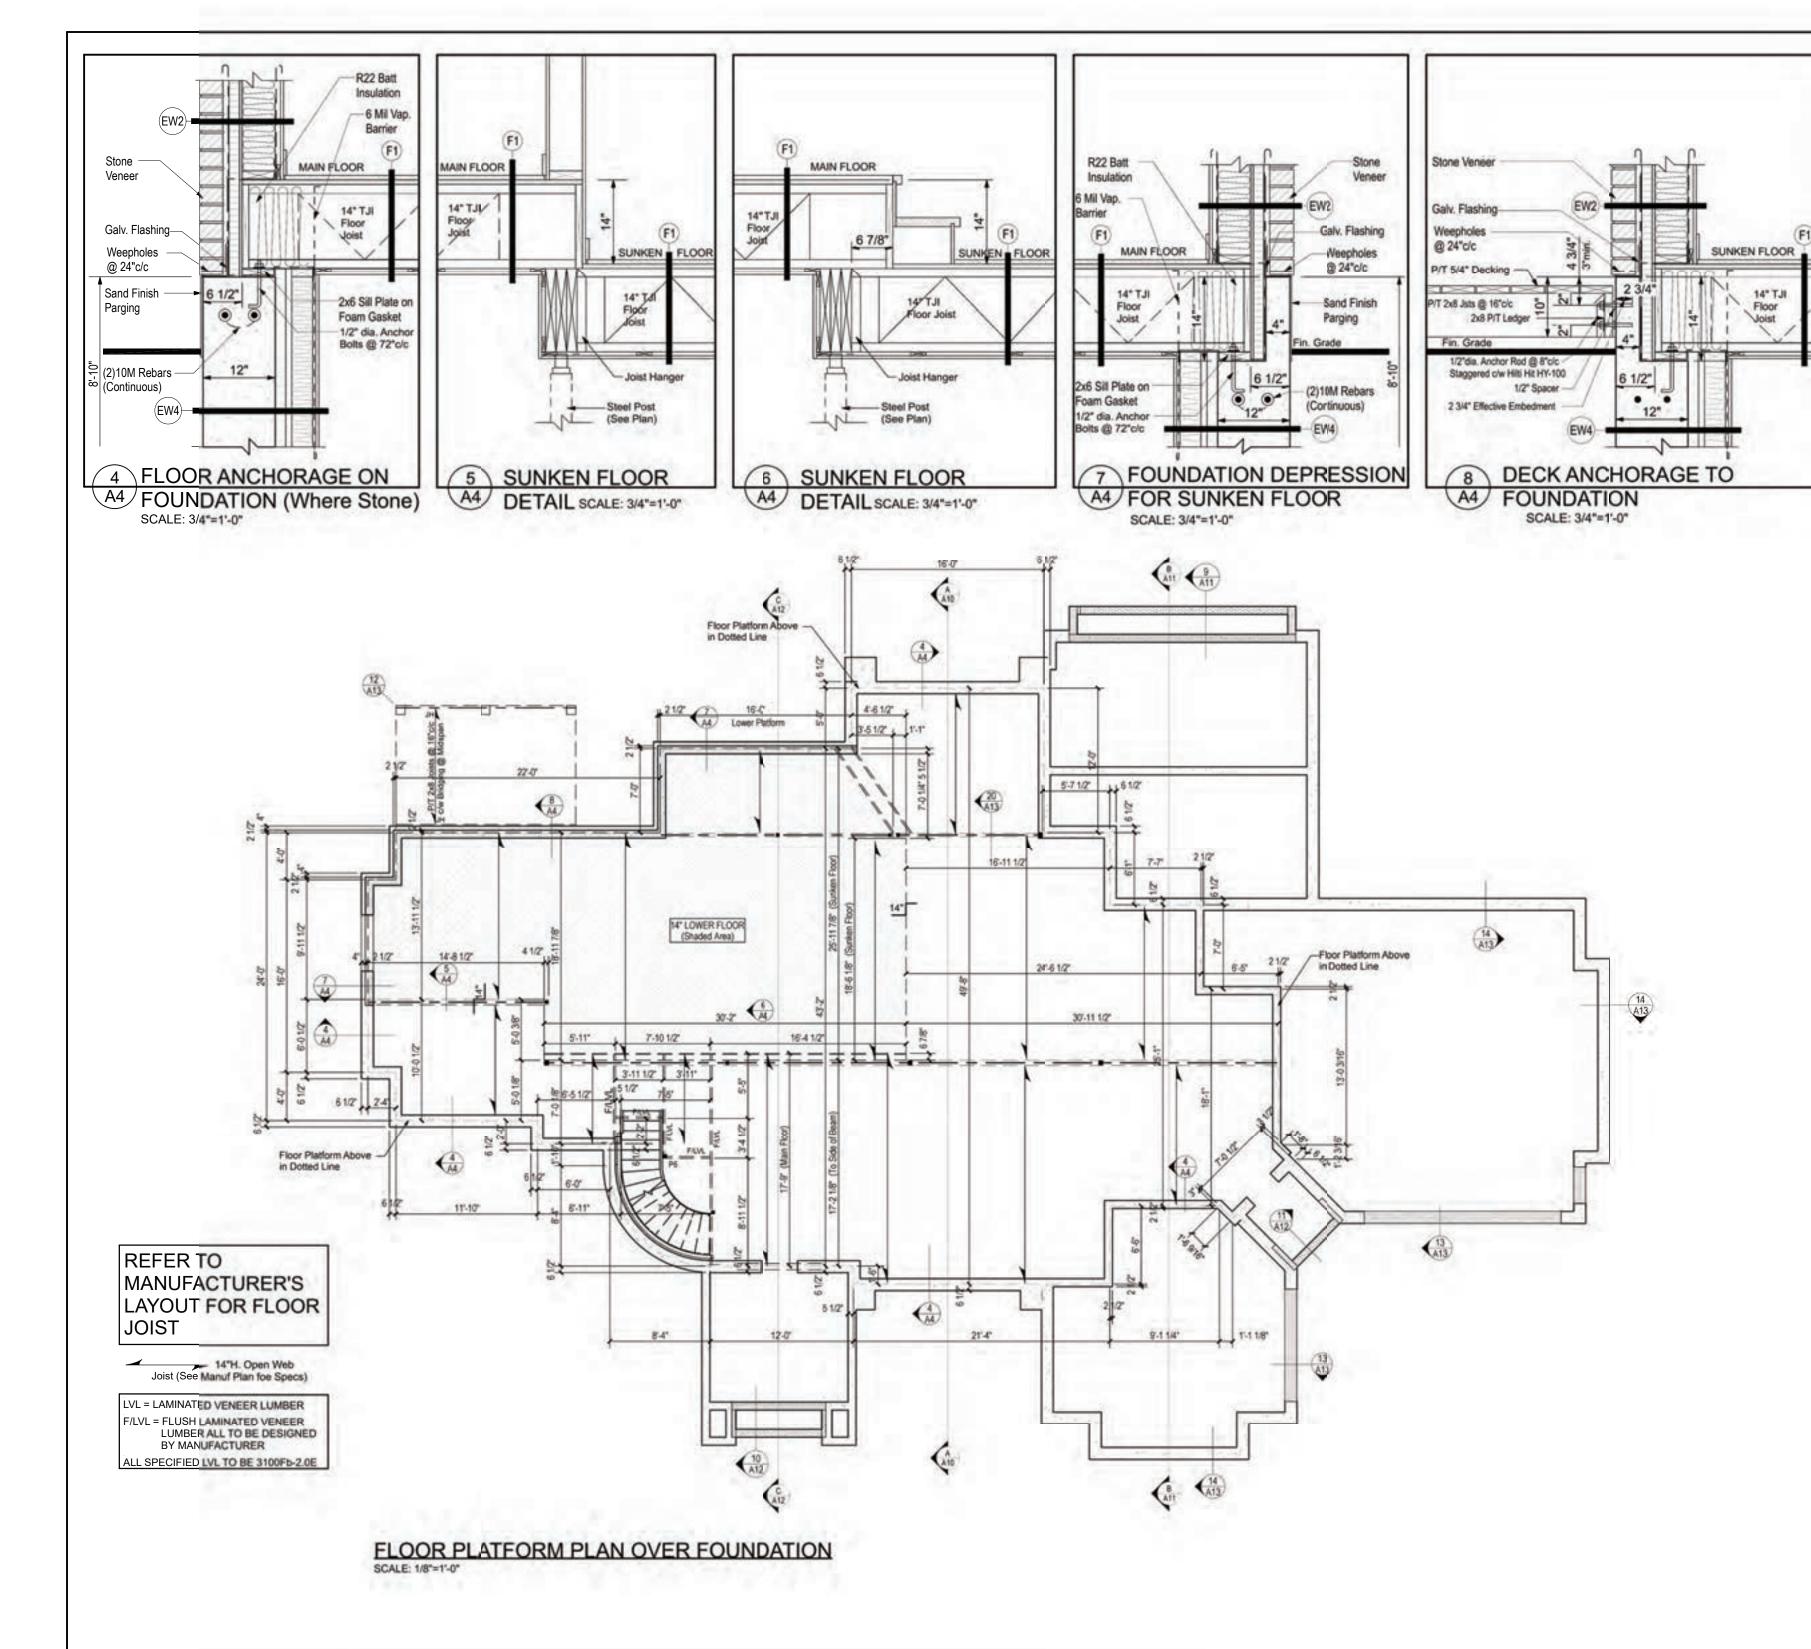



CONSTRUCTION PROJECT MANAGEMENT BY PARAGON HOMES

CUSTOM ENGINEERED HOME
PACKAGES-KIT BY PARAGON HOMES

LEGEND



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DATE	DESCRIPTION	REV
	First Preliminary Design Stage	01
2/27/2020	2nd Preliminary Design Stage	02
	3rd Preliminary-Design Stage	03
5/22/2020	Final Plan for General Review	04
	Final Plan for Structural Review	05
6/11/2020	Plan Issued for Building Permit	06
- consocioni	Market San Market San Art San	07

AL.

PROJECT ADDRESS
PROPOSED RESIDENCE
for Mr Ercan Indap
43, rue Place Madison
Hudson Qc, J0P 1H0
DRAWING TITLE

FLOOR PLATFORM PLAN


FRANK MURRAY N/A
PROJECT NUMBER DATE

AL-20-7

As Shown

A4 of 14

Feb. 2020

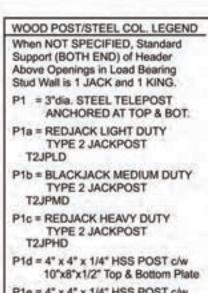

1 King NAILED TOGETHER)

P3 = (3)2x6 STUD POST (2 Jack + 1 King NAILED TOGETHER) P3a = (3)2x6 STUD POST

10"x8"x1/2" Top & Bottom Plate P1e = 4" x 4" x 1/4" HSS POST c/w 5 1/2"x8" Top Plate c/w (4)1/4" Lag Screw

5-6

7.7

P2 = (2)2x6 STUD POST (1 Jack + P2a = (2)2x6 STUD POST

(2 Kings NAILED TOGETHER)

(3 Kings NAILED TOGETHER) P4 = (4)2x6 STUD POST (3 Jack + 1 King NAILED TOGETHER)

P4a = (4)2x6 STUD POST (4 Kings NAILED TOGETHER) P5 = 4x4 WOOD POST P/T

P6 = 6x6 WOOD POST P/T \* = From Conc Pilar To Roof Beam P7 = 5 1/4" x 5 1/4" VERSA-LAM

If Header is NOT Tight Under Top Plates, Solid Blocking to Match Support shall be installed at Ends.

9.5

39-1"

REFER TO MANUFACTURER'S LAYOUT FOR FLOOR

2900Fb-2.0E

LVL 2 = (3)1 3/4" x 9 1/2" LP-LVL

2900Fb-2.0E

LVL 3 = (2)1 3/4" x 11 7/8" LP-LVL

2900Fb-2.0E

2900Fb-2.0E

2900Fb-2.0E

LVL = LAMINATED VENEER LUMBER

F/LVL = FLUSH LAMINATED VENEER

LUMBER ALL TO BE DESIGNED

LVL 5 = (3)1 3/4" x 14" LP-LVL

22-1

Electric Smoke & Carbon HEADER LEGEND: Monoxide Detector/w Battery All Header To Be (2)2x10 with P2 Back-up c/w Signaling Device UNLESS OTHERWISE NOTED. when in Bedoom, all Interconnected with Each Other LVL 1 = (2)1 3/4" x 9 1/2" LP-LVL

Provide Mechanical Exhaust to Outside

SEE FLOOR PLAN RELATED

A DETAIL OR SECTION NUMBER AN SHEET NO. WHERE TO FIND IT

NOTES ON A2

LEGEND:

Fan - Exhaust to Outside 2x6 Mechanical Wall

LVL 4 = (3)1 3/4" x 11 7/8" LP-LVL W# See WINDOW Schedule on A1

> CARRY ALL POINT LOAD DOWN TO FOOTING & FOUNDATION -

D# See DOOR Schedule on A1

STEEL ANGLE:

Joist (See Manuf Plan for Specs) STEELANGLE

BY MANUFACTURER ALL SPECIFIED LVL TO BE 2900Fb-2.0E L# = See steel Angle Table on A2 L#: SEE STEEL ANGLE LEGEND ON AZ 22" x 30" Attic Access c/w Weatherstrip & Min.imum R20 Rigid Insulation

MAISONS **PARAGON** HOMES 710-1180 Chemin d'Aylmer

Gatineau, Qc., J9H 0G5 OFFICE: (Qc) 1-819-503-6820 (On) 1-613-789-0220 CEL: 819-743-9220

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RECOMMENDATIONS OF THE MANUFACTURERS OF THE

DO NOT SCALE THE DRAWINGS.

APPLICABLE FOR ONTARIO SUB-TRADES.

DATE	DESCRIPTION	REV
and the second second second second	First Preliminary Design Stage	01
	2nd Preliminary Design Stage	02
	3rd Preliminary-Design Stage	03
31,000001000000000000000000000000000000	Final Plan for General Review	04
The second second second second	Final Plan for Structural Review	05
6/11/2020	Plan Issued for Building Permit	- 06
	NAME OF THE OWNER O	07

A.L.

**PROJECT ADDRESS** PROPOSED RESIDENCE for Mr Ercan Indap 43, rue Place Madison Hudson Qc, J0P 1H0 **DRAWING TITLE** 

**GROUND FLOOR PLAN** 


PROJECT DIRECTOR FILE NAME N/A FRANK MURRAY

PROJECT NUMBER AL-20-7

As Shown

Feb. 2020 DRAWING NUMBER

A5 of 14

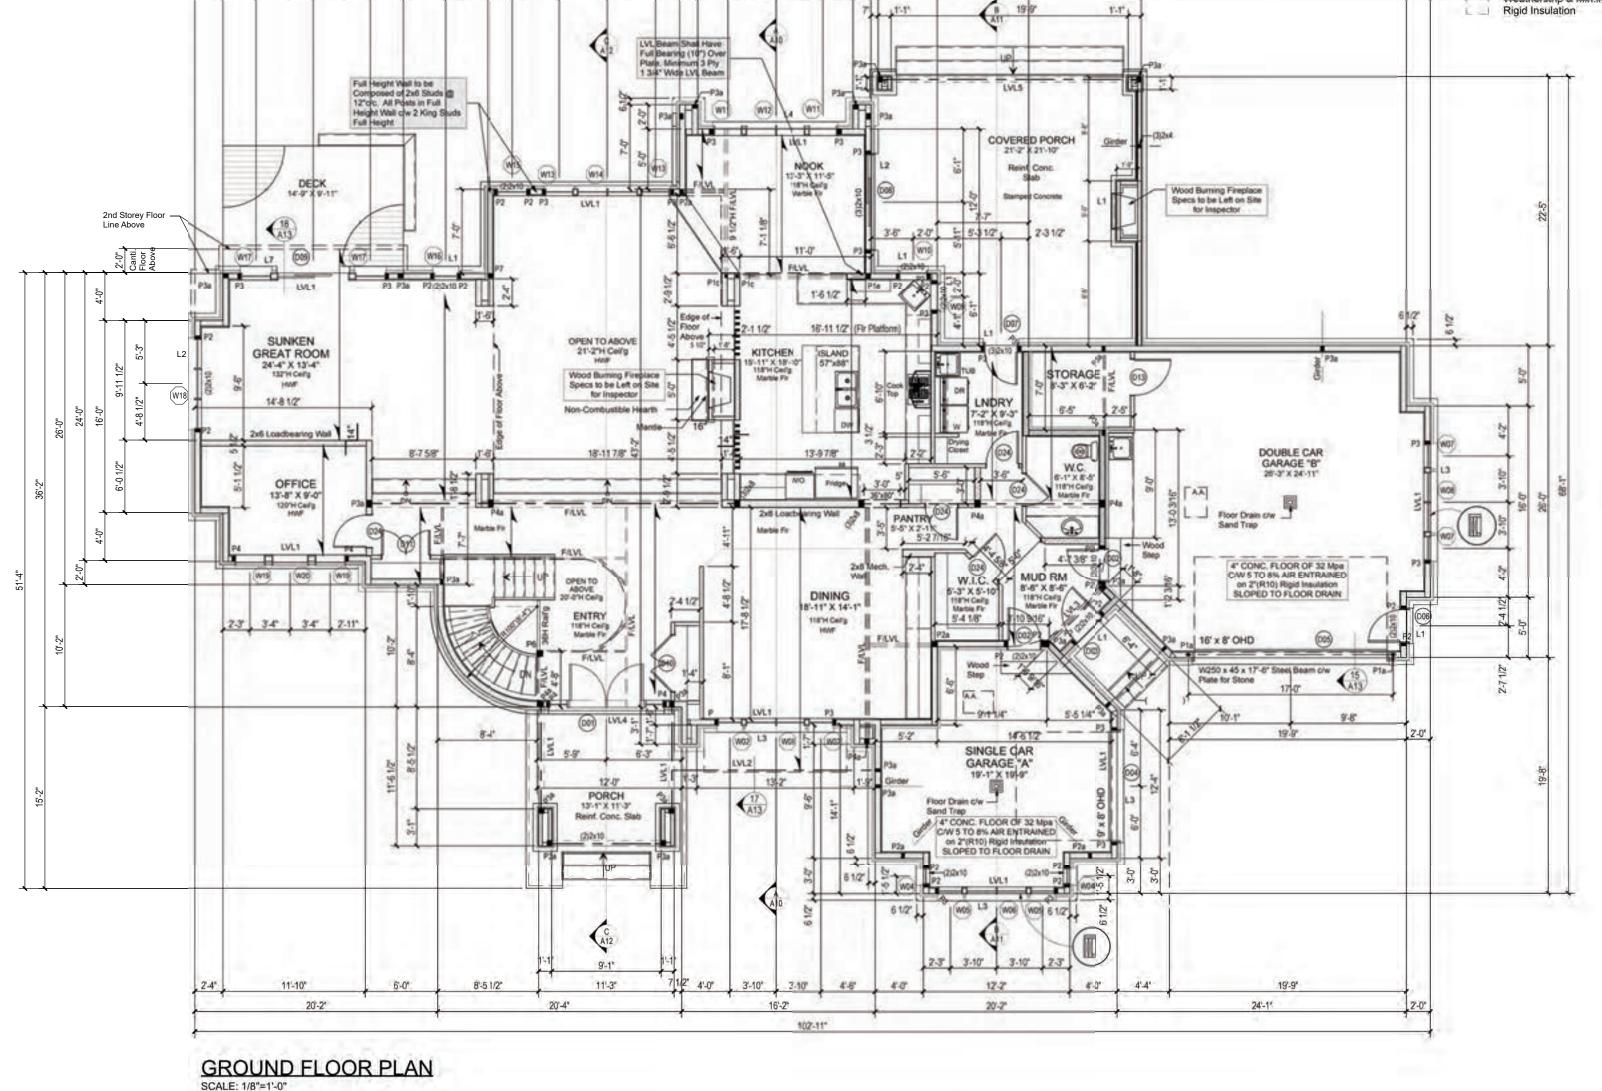

37'-6"

16'-0"

2'-6" 4'-0" 1 1-0" 1 2-6"

16'-0"

4'-0"

2'-1" L 3'-11" L 4'-0"

24'-4"

4'-9"

7'-0"

15'-0"

2'-9" k 4'-9" k

WOOD POST/STEEL COL. LEGEND When NOT SPECIFIED, Standard Support (BOTH END) of Header Above Openings in Load Bearing

Stud Wall is 1 JACK and 1 KING. P1 = 3'dia. STEEL TELEPOST ANCHORED AT TOP & BOT.

P1a = REDJACK LIGHT DUTY

TYPE 2 JACKPOST

T2JPLD P1b = BLACKJACK MEDIUM DUTY TYPE 2 JACKPOST

T2JPMD P1c = REDJACK HEAVY DUTY TYPE 2 JACKPOST

P1d = 4" x 4" x 1/4" HSS POST c/w 10"x8"x1/2" Top & Bottom Plate

P1e = 4" x 4" x 1/4" HSS POST c/w 5 1/2"x8" Top Plate c/w (4)1/4" Lag Screw

P2 = (2)2x6 STUD POST (1 Jack + 1 King NAILED TOGETHER)

P2a = (2)2x6 STUD POST (2 Kings NAILED TOGETHER)

P3 = (3)2x6 STUD POST (2 Jack + 1 King NAILED TOGETHER) P3a = (3)2x6 STUD POST

(3 Kings NAILED TOGETHER) P4 = (4)2x6 STUD POST (3 Jack + 1 King NAILED TOGETHER)

P4a = (4)2x6 STUD POST (4 Kings NAILED TOGETHER)

P5 = 4x4 WOOD POST P/T

P6 = 6x6 WOOD POST P/T \* = From Conc Pilar To Roof Beam P7 = 5 1/4" x 5 1/4" VERSA-LAM

If Header is NOT Tight Under Top Plates, Solid Blocking to Match Support shall be Installed at Ends. REFER TO MANUFACTURER'S LAYOUT FOR FLOOR

HEADER LEGEND: All Header To Be (2)2x10 with P2

LVL 1 = (2)1 3/4" x 9 1/2" LP-LVL

2900Fb-2.0E LVL 2 = (3)1 3/4" x 9 1/2" LP-LVL 2900Fb-2.0E

LVL 3 = (2)1 3/4" x 11 7/8" LP-LVL 2900Fb-2.0E

LVL 4 = (3)1 3/4" x 11 7/8" LP-LVL 2900Fb-2.0E LVL 5 = (3)1 3/4" x 14" LP-LVL 2900Fb-2.0E

LVL = LAMINATED VENEER LUMBER F/LVL = FLUSH LAMINATED VENEER LUMBER ALL TO BE DESIGNED

BY MANUFACTURER ALL SPECIFIED LVL TO BE 2900Fb-2.0E

SEE FLOOR PLAN RELATED NOTES ON A2 LEGEND:

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Electric Smoke & Carbon Monoxide Detector/w Battery Back-up c/w Signaling Device when in Bedoom, all Interconnected with Each Other

Provide Mechanical Exhaust to Outside

Fan - Exhaust to Outside 2x6 Mechanical Wall

W# See WINDOW Schedule on A1 D# See DOOR Schedule on A1

> CARRY ALL POINT LOAD DOWN TO FOOTING & FOUNDATION -

STEEL ANGLE:

L# = See steel Angle Table on A2

Joist (See Manuf Plan foe Specs)

STEELANGLE

L# : SEE STEEL ANGLE LEGEND ON AZ

22" x 30" Attic Access c/w Weatherstrip & Min.imum R20 Rigid Insulation



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LEGEND



P.ENG STAMP FOR DESIGN OF PRIMARY STRUCTURAL ELEMENTS ONLY. JUNE 12, 2020

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RECOMMENDATIONS OF THE MANUFACTURERS OF THE

DO NOT SCALE THE DRAWINGS.

MATERIAL OR EQUIPMENT.

DATE	DESCRIPTION	REV
	First Preliminary Design Stage	01
	2nd Preliminary Design Stage	02
	3rd Preliminary-Design Stage	03
	Final Plan for General Review	04
	Final Plan for Structural Review	05
6/11/2020	Plan Issued for Building Permit	06
Chicken Street	PARTY AND CONTROL OF THE PARTY AND ADDRESS OF	07

A.L.

**PROJECT ADDRESS** PROPOSED RESIDENCE for Mr Ercan Indap 43, rue Place Madison Hudson Qc, J0P 1H0 **DRAWING TITLE** 


**GROUND FLOOR PLAN** 

PROJECT DIRECTOR FRANK MURRAY FILE NAME N/A

PROJECT NUMBER AL-20-7


Feb. 2020

DRAWING NUMBER A6 of 14 As Shown

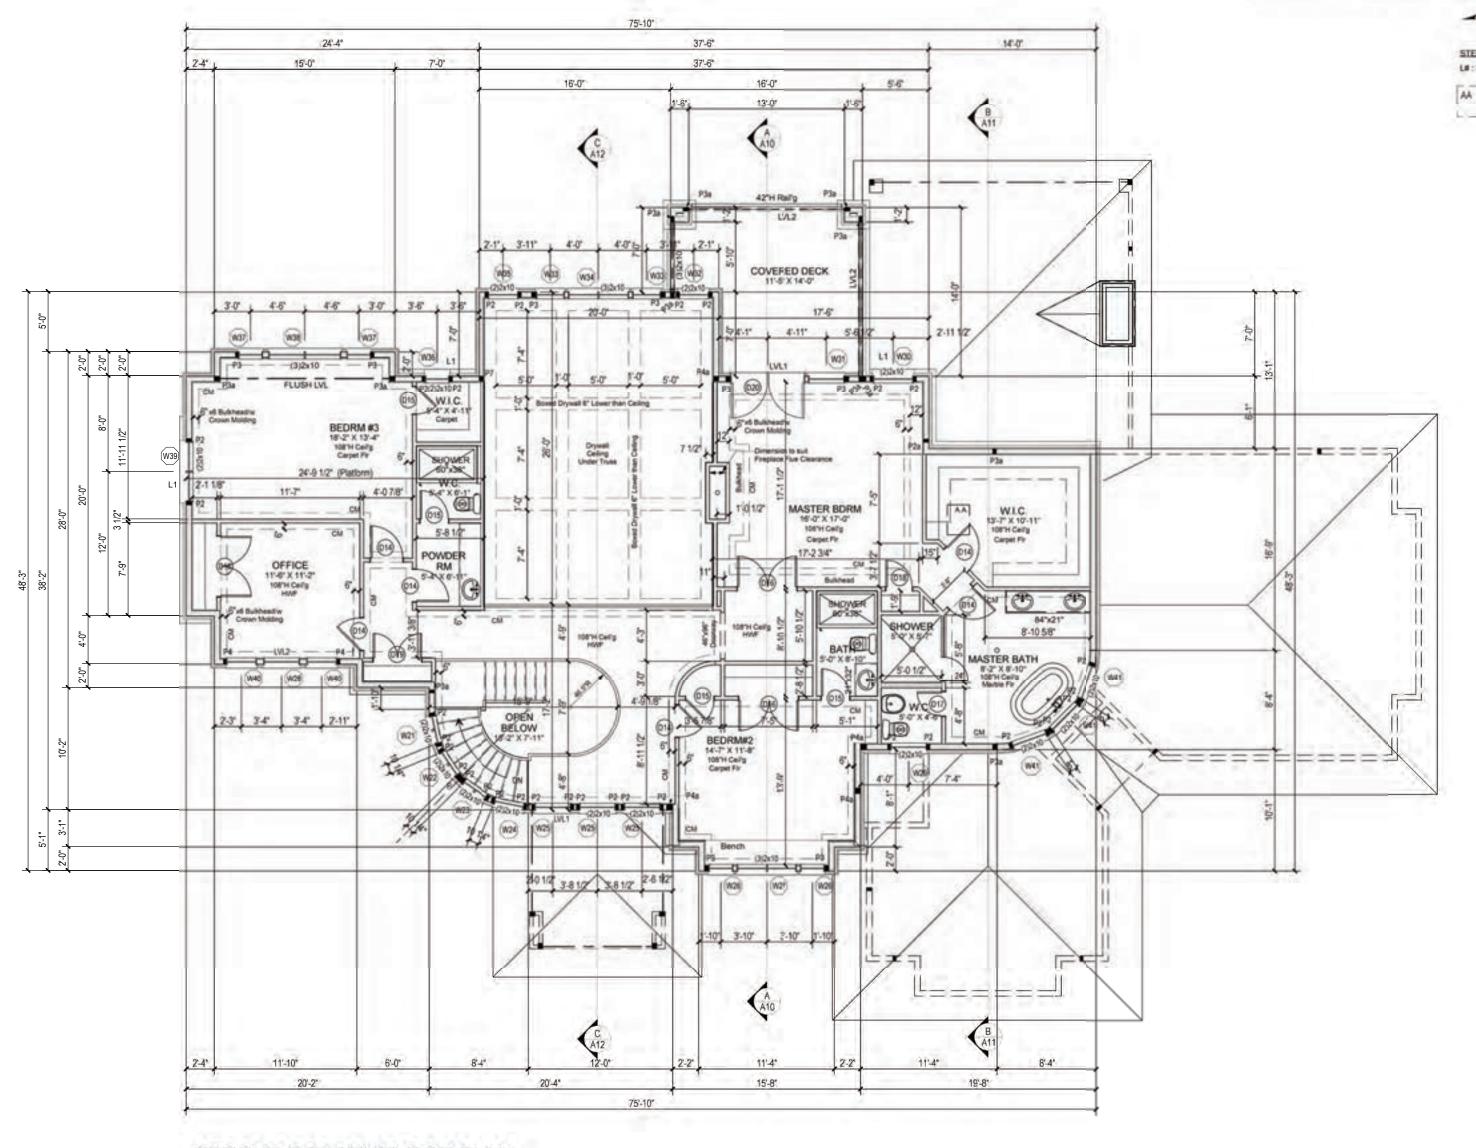

SECOND STOREY FLOOR PLAN

SCALE: 1/8"=1'-0"

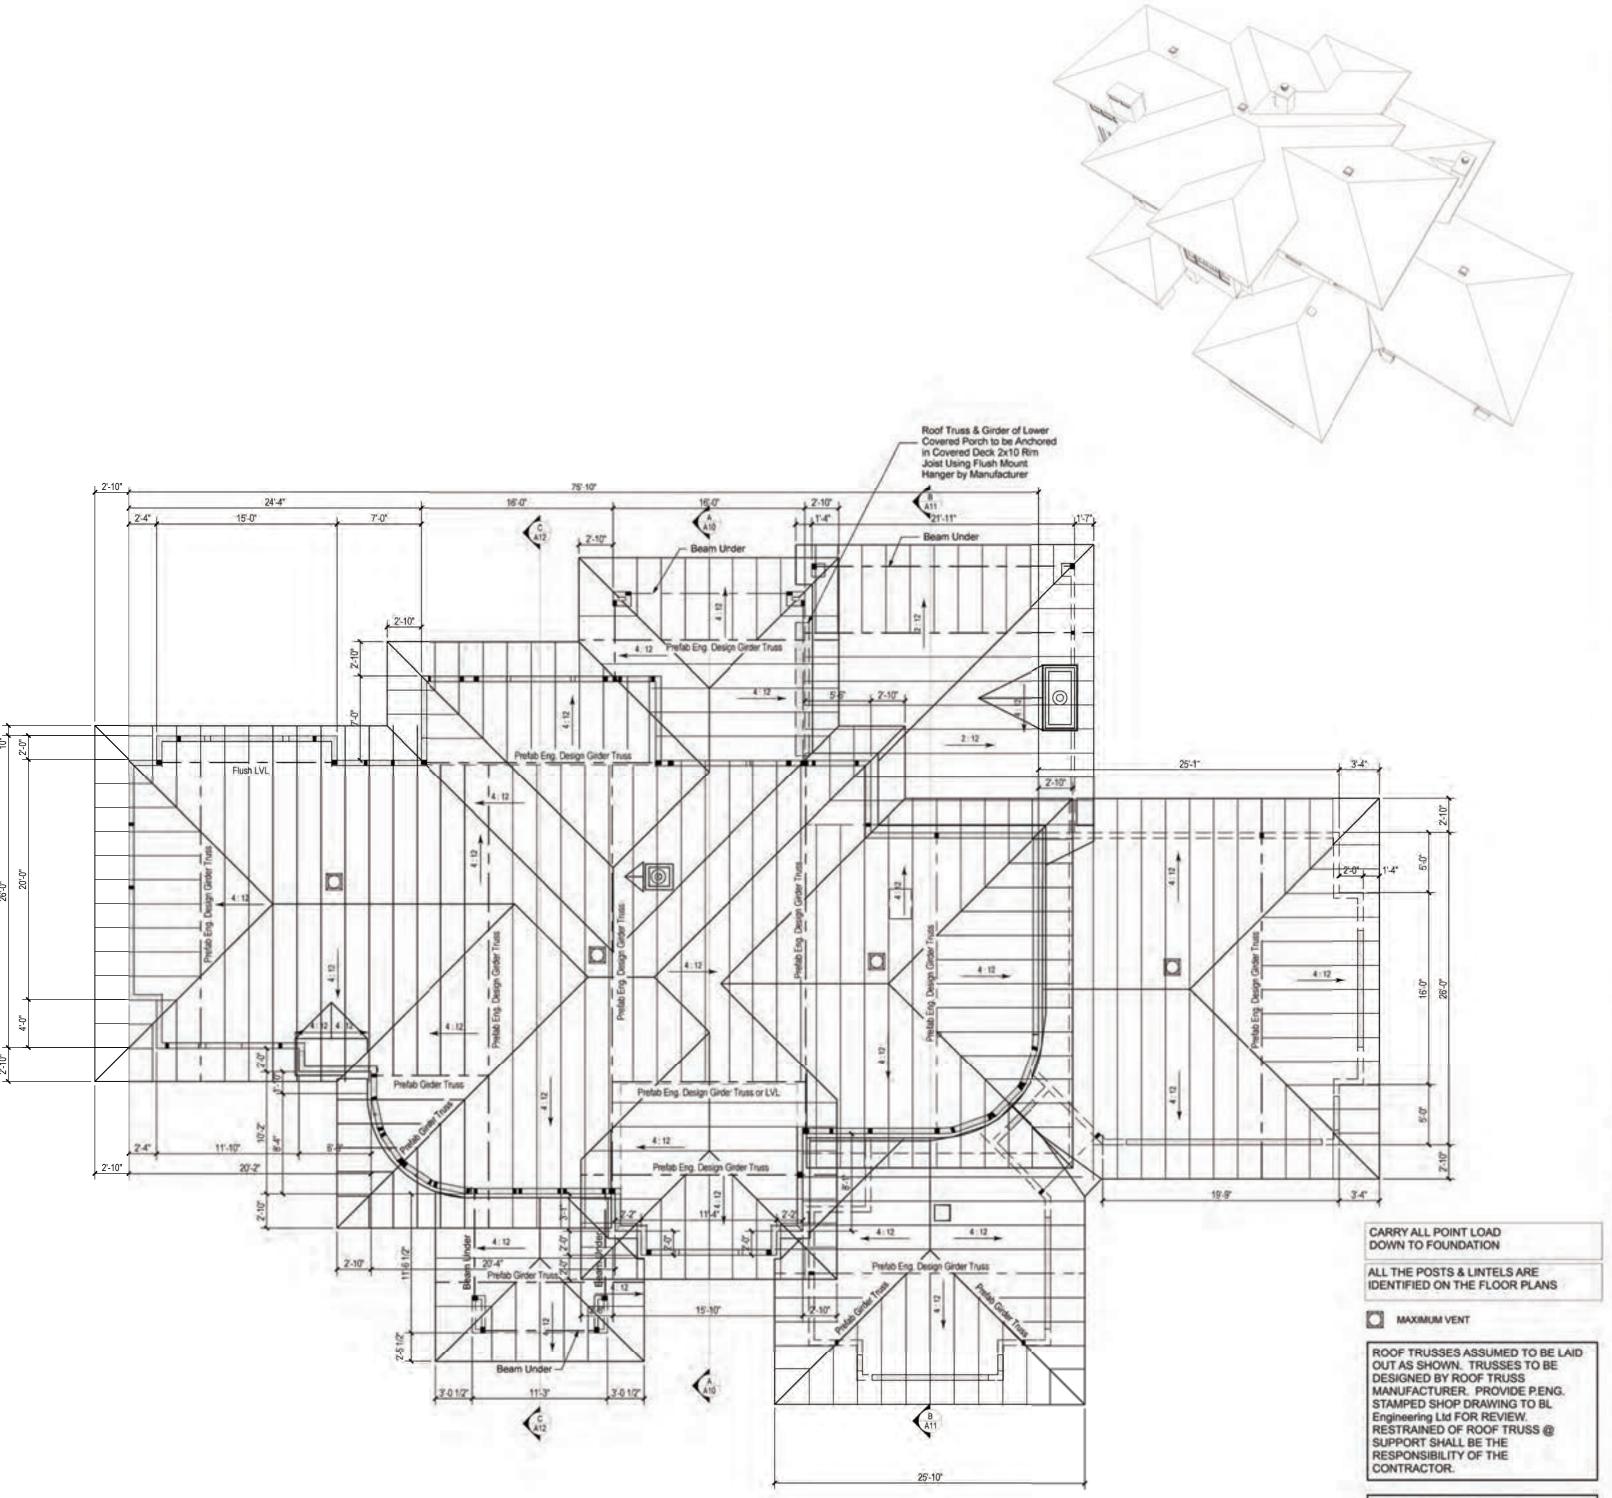

**ROOF PLAN** 

SCALE: 1/8"=1'-0"



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DATE m/d/y	DESCRIPTION	REV
	First Preliminary Design Stage	01
	2nd Preliminary Design Stage	02
	3rd Preliminary-Design Stage	03
	Final Plan for General Review	04
ACTION AND ADDRESS OF THE PARTY	Final Plan for Structural Review	05
6/11/2020	Plan Issued for Building Permit	06
or exchanges	New Anthrope Court of Court of	07

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**PROJECT ADDRESS** PROPOSED RESIDENCE for Mr Ercan Indap 43, rue Place Madison Hudson Qc, J0P 1H0 DRAWING TITLE **ROOF PLAN** 

PROJECT DIRECTOR FILE NAME N/A FRANK MURRAY


PROJECT NUMBER AL-20-7 SCALE

As Shown

Feb. 2020 DRAWING NUMBER A7 of 14

DATE

WHEN ROOF TRUSSES ARE SUPPORTED AT 2nd STOREY FLOOR LEVEL THEY SHALL BE ANCHORED DIRECTLY IN THE RIM USING FLUSH MOUNT HANGER. MINIMUM RIM JOIST SIZE TO BE 1 1/8" THICK.

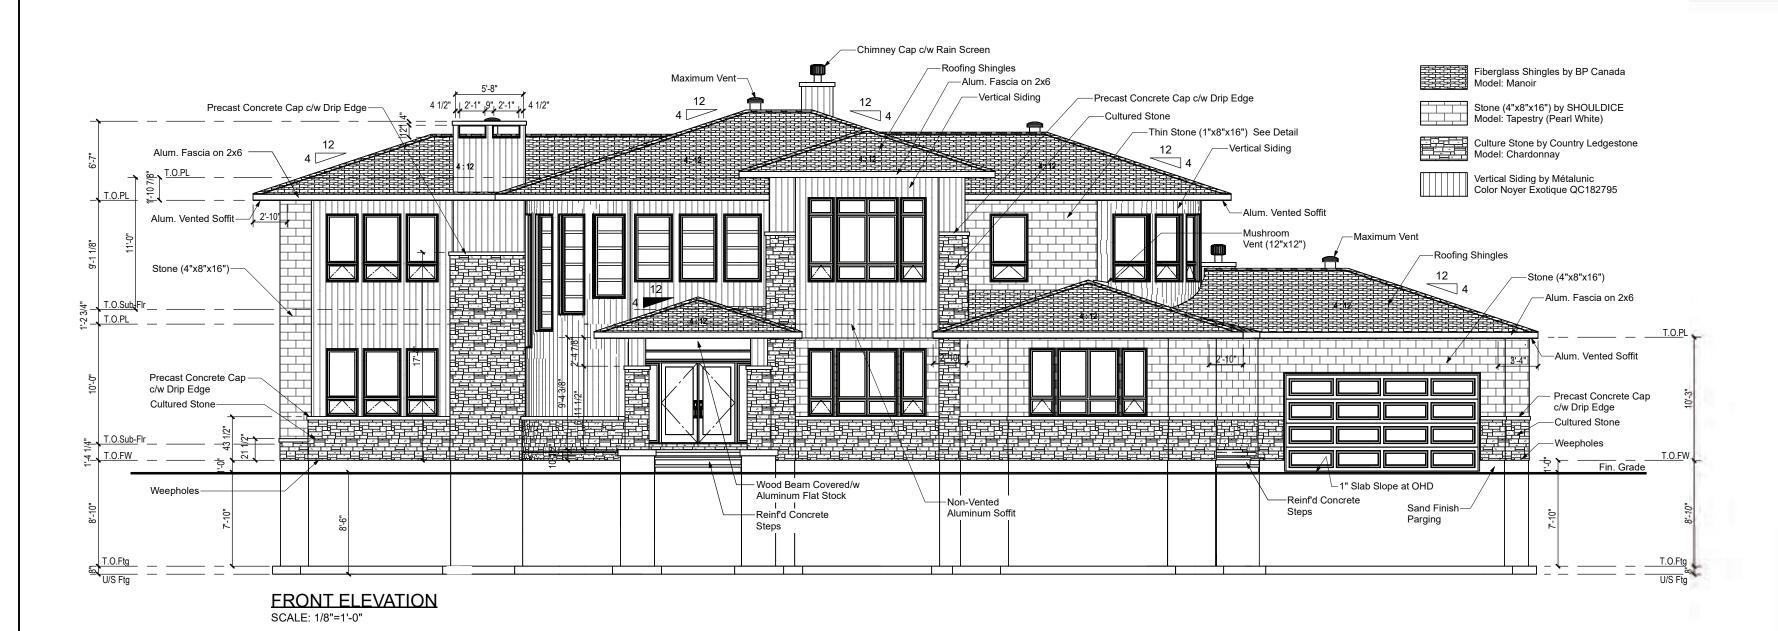

					WINDOW SCH	EDULE	
#	FLR	ROOM NAME	QTY	DIMENSIONS W X H	DESCRIPTION	COMMENTS	TOP FROM FLOOR
W01	0	BEDRM#3	1	56"X24"TS	TRIPLE SLIDING	EXIT WINDOW. SEE NOTE BN7 ON A2	87"
W02	1	DINING	2	24"X66"	MULLED UNIT-HR	16 1/2"H AWNING + 49 1/2"H FIXED	94 1/2"
W03	1	DINING	1	60"X66"	MULLED UNIT-HR	DB L16 1/2"H AWNING + 49 1/2"H DBL FIXED	94 1/2"
W04	1	SINGLE CAR GARAGE "A"	2	16"X66"	MULLED UNIT-HR	16 1/2"H AWNING + 49 1/2"H FIXED	122 1/8"
W05	1	SINGLE CAR GARAGE "A"	2	24"X66"	MULLED UNIT-HR	16 1/2"H AWNING + 49 1/2"H FIXED	122 1/8"
W06	1	SINGLE CAR GARAGE "A"	1	60"X66"	MULLED UNIT-HR	DBL 16 1/2"H AWNING + 49 1/2"H DBL FIXED	122 1/8"
W07	1	DOUBLE CAR GARAGE "B"	2	24"X66"	MULLED UNIT-HR	16 1/2"H AWNING + 49 1/2"H FIXED	122 1/8"
W08	1	DOUBLE CAR GARAGE "B"	1	60"X66"	MULLED UNIT-HR	DBL 16 1/2"H AWNING + 49 1/2"H DBL FIXED	122 1/8"
W09	1	KITCHEN/COVERED PORCH	11	28"X46"SC	SINGLE CASEMENT-HL		89"
W10	1	KITCHEN/COVERED PORCH	<del>  i                                   </del>	28"X46"SC	SINGLE CASEMENT-HR		89"
W11	1	NOOK	2	28"X99"	MULLED UNIT-HR	16 1/2"H AWNING + 66"H FIXED + 16 1/2"H TRANSOM	105 1/2"
W12	1	NOOK	1 1	60"X99"	MULLED UNIT-HR	DBL 16 1/2"H AWNING + 66"H FIXED + 16 1/2"H TRANSOM	105 1/2"
W13	11	SUNKEN LIVINGROOM	1 2	28"X99"	MULLED UNIT-HR	16 1/2"H AWNING + 66"H FIXED + 16 1/2"H TRANSOM	119 1/2"
W14	1	SUNKEN LIVINGROOM	1 1	60"X99"	MULLED UNIT-HR	DBL 16 1/2"H AWNING + 66"H FIXED + 16 1/2" TRANSOM	119 1/2"
W15	1	SUNKEN LIVINGROOM	<del>                                     </del>	30"X99"	MULLED UNIT-HR	5 LITES	119 1/2"
W16	1	SUNKEN GREAT ROOM	<del>                                     </del>	24"X82 1/2"	MULLED UNIT-HR	16 1/2"H AWNING +49 1/2"H FIXED + 16 1/2" TRANSOM	103"
W17	1	SUNKEN GREAT ROOM/DECK	1 2	30"X82 1/2"	MULLED UNIT-HR	16 1/2"H AWNING + 49 1/2"H FIXED + 16 1/2"H TRANSOM	103"
W18	1	SUNKEN GREAT ROOM	1 1	90"X82 1/2"	MULLED UNIT-HR	TPL 16 1/2"H AWNING + TPL 49 1/2"H FIXED + TPL 16 1/2"H TRANSOM	103"
W19	1	OFFICE	2	30"X66"	MULLED UNIT-HR	16 1/2"H AWNING + 49 1/2"H FIXED	94 1/2"
W20	1	OFFICE	1 1	36"X66"	MULLED UNIT-HR	16 1/2"H AWNING + 49 1/2"H FIXED	94 1/2"
W21	2	OPEN BELOW	<del>                                     </del>	28"X132"FX	FIXED GLASS	7 LITES	94 1/2"
W22	2	OPEN BELOW	<del>                                     </del>	28"X115 1/2"FX		6 LITES	94 1/2"
W23	2	OPEN BELOW	<del>                                     </del>	28"X99"FX	FIXED GLASS	5 LITES	94 1/2"
W24	2	OPEN BELOW	<del>                                     </del>	30"X82 1/2"FX	FIXED GLASS	4 LITES	94 1/2"
W25	2	UNSPECIFIED	3	36"X66"FX	FIXED GLASS	3 LITES	94 1/2"
W26	2	BEDRM#2	2	24"X82 1/2"	MULLED UNIT-HR	16 1/2"H AWNING + 49 1/2"H FIXED + 16 1/2"H TRANSOM	111"
W27	2	BEDRM#2	1 1	60"X82 1/2"	MULLED UNIT-HR	DBL 16 1/2"H FIXED + 49 1/2"H DBL FIXED + 16 1/2"H DBL TRANSOM	111"
W28	2	OFFICE	+ †	36"X66"	MULLED UNIT-HR	16 1/2"H AWNING + 49 1/2"H FIXED	94 1/2"
W29	2	W.C.	<del>                                     </del>	36"X66"	MULLED UNIT-HR	16 1/2"H AWNING + 49 1/2"H FIXED	94 1/2"
W30	2	MASTER BDRM	1	40"X48"FX	FIXED GLASS	10 1/2 11 AWINING + 40 1/2 111 IALD	82 1/2"
	$\vdash$	MASTER BDRM/COVERED	+				
W31	2	DECK	1	36"X80"FX	FIXED GLASS		81 1/2"
W32	2	OPEN BELOW/COVERED	1	30"X82 1/2"	MULLED UNIT-HL	4 LITES	94 1/2"
W33	2	DECK OPEN BELOW	2	28"X82 1/2"	MULLED UNIT-HR	16 1/2"H FIXED +49 1/2"H FIXED + 16 1/2" TRANSOM	94 1/2"
W34	2	OPEN BELOW	1 1	60"X82 1/2"	MULLED UNIT-HR	DBL 16 1/2"H FIXED + 49 1/2"H FIXED + 16 1/2"H DBL TRANSOM	94 1/2"
W35	2	OPEN BELOW	1 1	30"X82 1/2"	MULLED UNIT-HR	4 LITES	94 1/2"
W36	2	W.I.C.	1 1	24"X66"	MULLED UNIT-HR	16 1/2"H AWNING + 49 1/2"H FIXED	94 1/2"
W37	2	BEDRM #3	2	24"X66"	MULLED UNIT-HR	16 1/2"H AWNING + 49 1/2"H FIXED	94 1/2"
W38	2	BEDRM #3	1	72"X66"	MULLED UNIT-HR	DBL 16 1/2"H AWNING + 49 1/2"H DBL FIXED	94 1/2"
W39	2	BEDRM #3	1 1	60"X66"	MULLED UNIT-HR	DBL 16 1/2"H AWNING + 49 1/2"H DBL FIXED	94 1/2"
W40	2	OFFICE	2	30"X66"	MULLED UNIT-HR	16 1/2"H AWNING + 49 1/2"H FIXED	94 1/2"
W41	2	MASTER BATH		36"X66"	MULLED UNIT-HR	16 1/2"H AWNING + 49 1/2"H FIXED	94 1/2"
VV <del>'I</del> I	14		ı	100 A00	INIOFFED OINLI-LIU		13 <del>4</del> 1/2

## P.S.: ALL DIMENSIONS ARE FRAME NOT R.O.

1- REFER TO ELEVATIONS FOR WINDOW STYLE BUT NOTE THAT THE EXACT WINDOW STYLE SHALL BE CONFIRM BY THE HOME OWNERS PRIOR TO ORDERING OR MANUFACTURING. SHOP DRAWINGS SHALL BE PROVIDED TO THE OWNER AND GENERAL CONTRACTOR FOR REVIEW PRIOR TO PLACING ORDER. ANY VARIANCE SHALL BE RESOLVED BY THE OWNER/GENERAL CONTRACTOR.

## **IMPORTANT NOTES:**

#### MISCELLANEOUS:

- Caulk over and around all exterior openings using non-hardening caulking compound. - Flash all changes of materials on exterior walls. - All siding to be a minimum of 8" (200mm) above finish grade.

## ABOVE GRADE MASONRY:

- All above grade masonry is to conform to the Ontario Building Code. At the brick or stone veneer, counterflashing shall be up 8" (200mm) behind the building felt and below the bottom course with vertical joints (weepholes) @ 24"c/c (600mm) raked clean.

- Brick or Stone veneer tie spacing to be at maximum vertical spacing of 16" (400mm) and a maximum vertical spacing of 24" (600mm) or a maximum horizontal of 24" (600mm) and a maximum vertical spacing of 20" (500mm) to coincide with wall stud spacing.

## **ROOFING:**

- All roofing shall be applied according to the manufacturer's recommendations and conform to Ontario Building Code.
- Minimum two layers of felt paper shall be installed on extending 30" (750mm) on roof from the inner

## of the exterior wall. SHEET METAL:

- All required flashing to be 28 Ga. galvanized metal unless otherwise specified on plans. ALL OVERHANG DIMENSIONS ARE FROM FACE OF STUD TO FACE OF FASCIA BOARD.
- PROVIDE PROPER ATTIC VENTILATION NEAR ROOF PEAK 1/300min. OF INSULATED CEILING

					DOOR	SCHEDULE
#	EX/IN	QTY	FLR	DOOR DIMENSIONS	TYPE	DESCRIPTION
D01	EX	1	1	114"X93 1/4"	MULLED UNIT	(2)36" DOOR C/W SIDELIGHT ON BOTH SIDE & TRANSOM
D02	EX	2	1	32"X80"	HINGED	MTL INSULATED
D03	EX	1	1	36"X80"	HINGED	MTL INSULATED
D04	EX	1	1	9'X8' OHD	GARAGE	GARAGA CALIFORNIA
D05	EX	1	1	16'X8' OHD	GARAGE	GARAGA CALIFORNIA
D06	EX	1	1	32"X80"	HINGED	MTL INSULATED C/W 3/4 GLASS
D07	EX	1	1	32"X80"-	HINGED	MTL INSULATED C/W 3/4 GLASS
D08	EX	1	1	95"X101 3/4"	MULLED UNIT	PATIO SLIDING DOOR C/W TRANSOM
D09	EX	1	1	71"X101 3/4"	MULLED UNIT	PATIO SLIDING DOOR C/W TRANSOM
D10	IN	1	1	56"X80"	DOUBLE HINGED	MANF: MASONITE, MODEL SELECT RIVERSIDE
D11	IN	1	1	48"X80"	DOUBLE HINGED	MANF: MASONITE, MODEL SELECT RIVERSIDE
D13	IN	1	1	36"X80"	HINGED	MANF: MASONITE, MODEL SELECT RIVERSIDE
D14	IN	6	2	32"X80"	HINGED	MANF: MASONITE, MODEL SELECT RIVERSIDE
D15	IN	4	2	28"X80"	HINGED	MANF: MASONITE, MODEL SELECT RIVERSIDE
	IN	3	2	60"X80"	DOUBLE HINGED	MANF: MASONITE, MODEL SELECT RIVERSIDE
D17	IN	1	2	24"X80"	HINGED	MANF: MASONITE, MODEL SELECT RIVERSIDE
D18	IN	1	2	26"X80"	HINGED	MANF: MASONITE, MODEL SELECT RIVERSIDE
D19	IN	1	2	48"X80"	DOUBLE HINGED	MANF: MASONITE, MODEL SELECT RIVERSIDE
D20		1	2	74"X80"	MULLED UNIT	PATIO SLIDING DOOR
D21	INEX	1	0	72"X80"	DOUBLE HINGED	MANF: MASONITE, MODEL SELECT RIVERSIDE
D22	IN	3	0	32"X80"	HINGED	MANF: MASONITE, MODEL SELECT RIVERSIDE
D23	IN	3	0	36"X80"	HINGED	MANF: MASONITE, MODEL SELECT RIVERSIDE
D24	IN	5	1	32"X80"	HINGED	MANF: MASONITE, MODEL SELECT RIVERS DE

P.S.: ALL DIMENSIONS ARE FRAME NOT R.O.

Mulled Unit= Door c/w Sidelight(s) & Transom or Both



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## **CUSTOM ENGINEERED HOME** PACKAGES-KIT BY PARAGON HOMES

LEGEND



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2/27/2020	2rd Preliminary Design Stage	02
3/17/2020	3rd Preliminary-Design Stage	03
5/22/2020	Final Plan for General Review	04
5/26/2020	Final Plan for Structural Review	05
6/11/2020	Plan Issued for Building Permit	06
Special Control	Car year or was a second or the	07

PROJECT ADDRESS PROPOSED RESIDENCE for Mr Ercan Indap 43, rue Place Madison Hudson Qc, J0P 1H0

PROJECT DIRECTOR FRANK MURRAY


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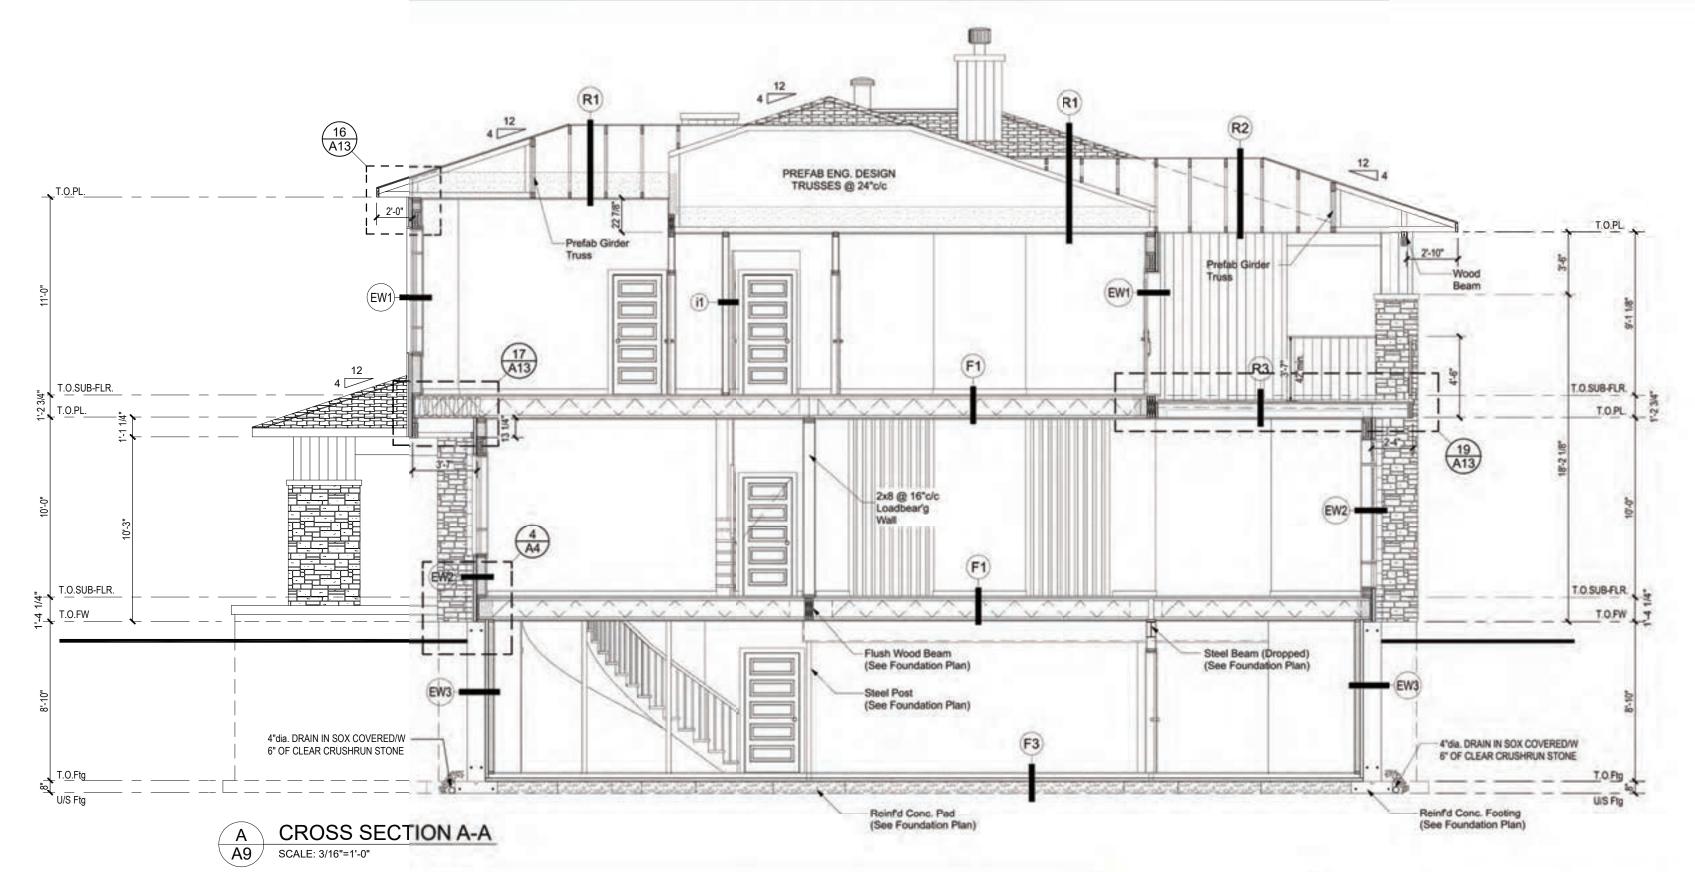
FILE NAME N/A

PROJECT NUMBER AL-20-7

Feb. 2020 DRAWING NUMBER

**A8** of 14 As Shown



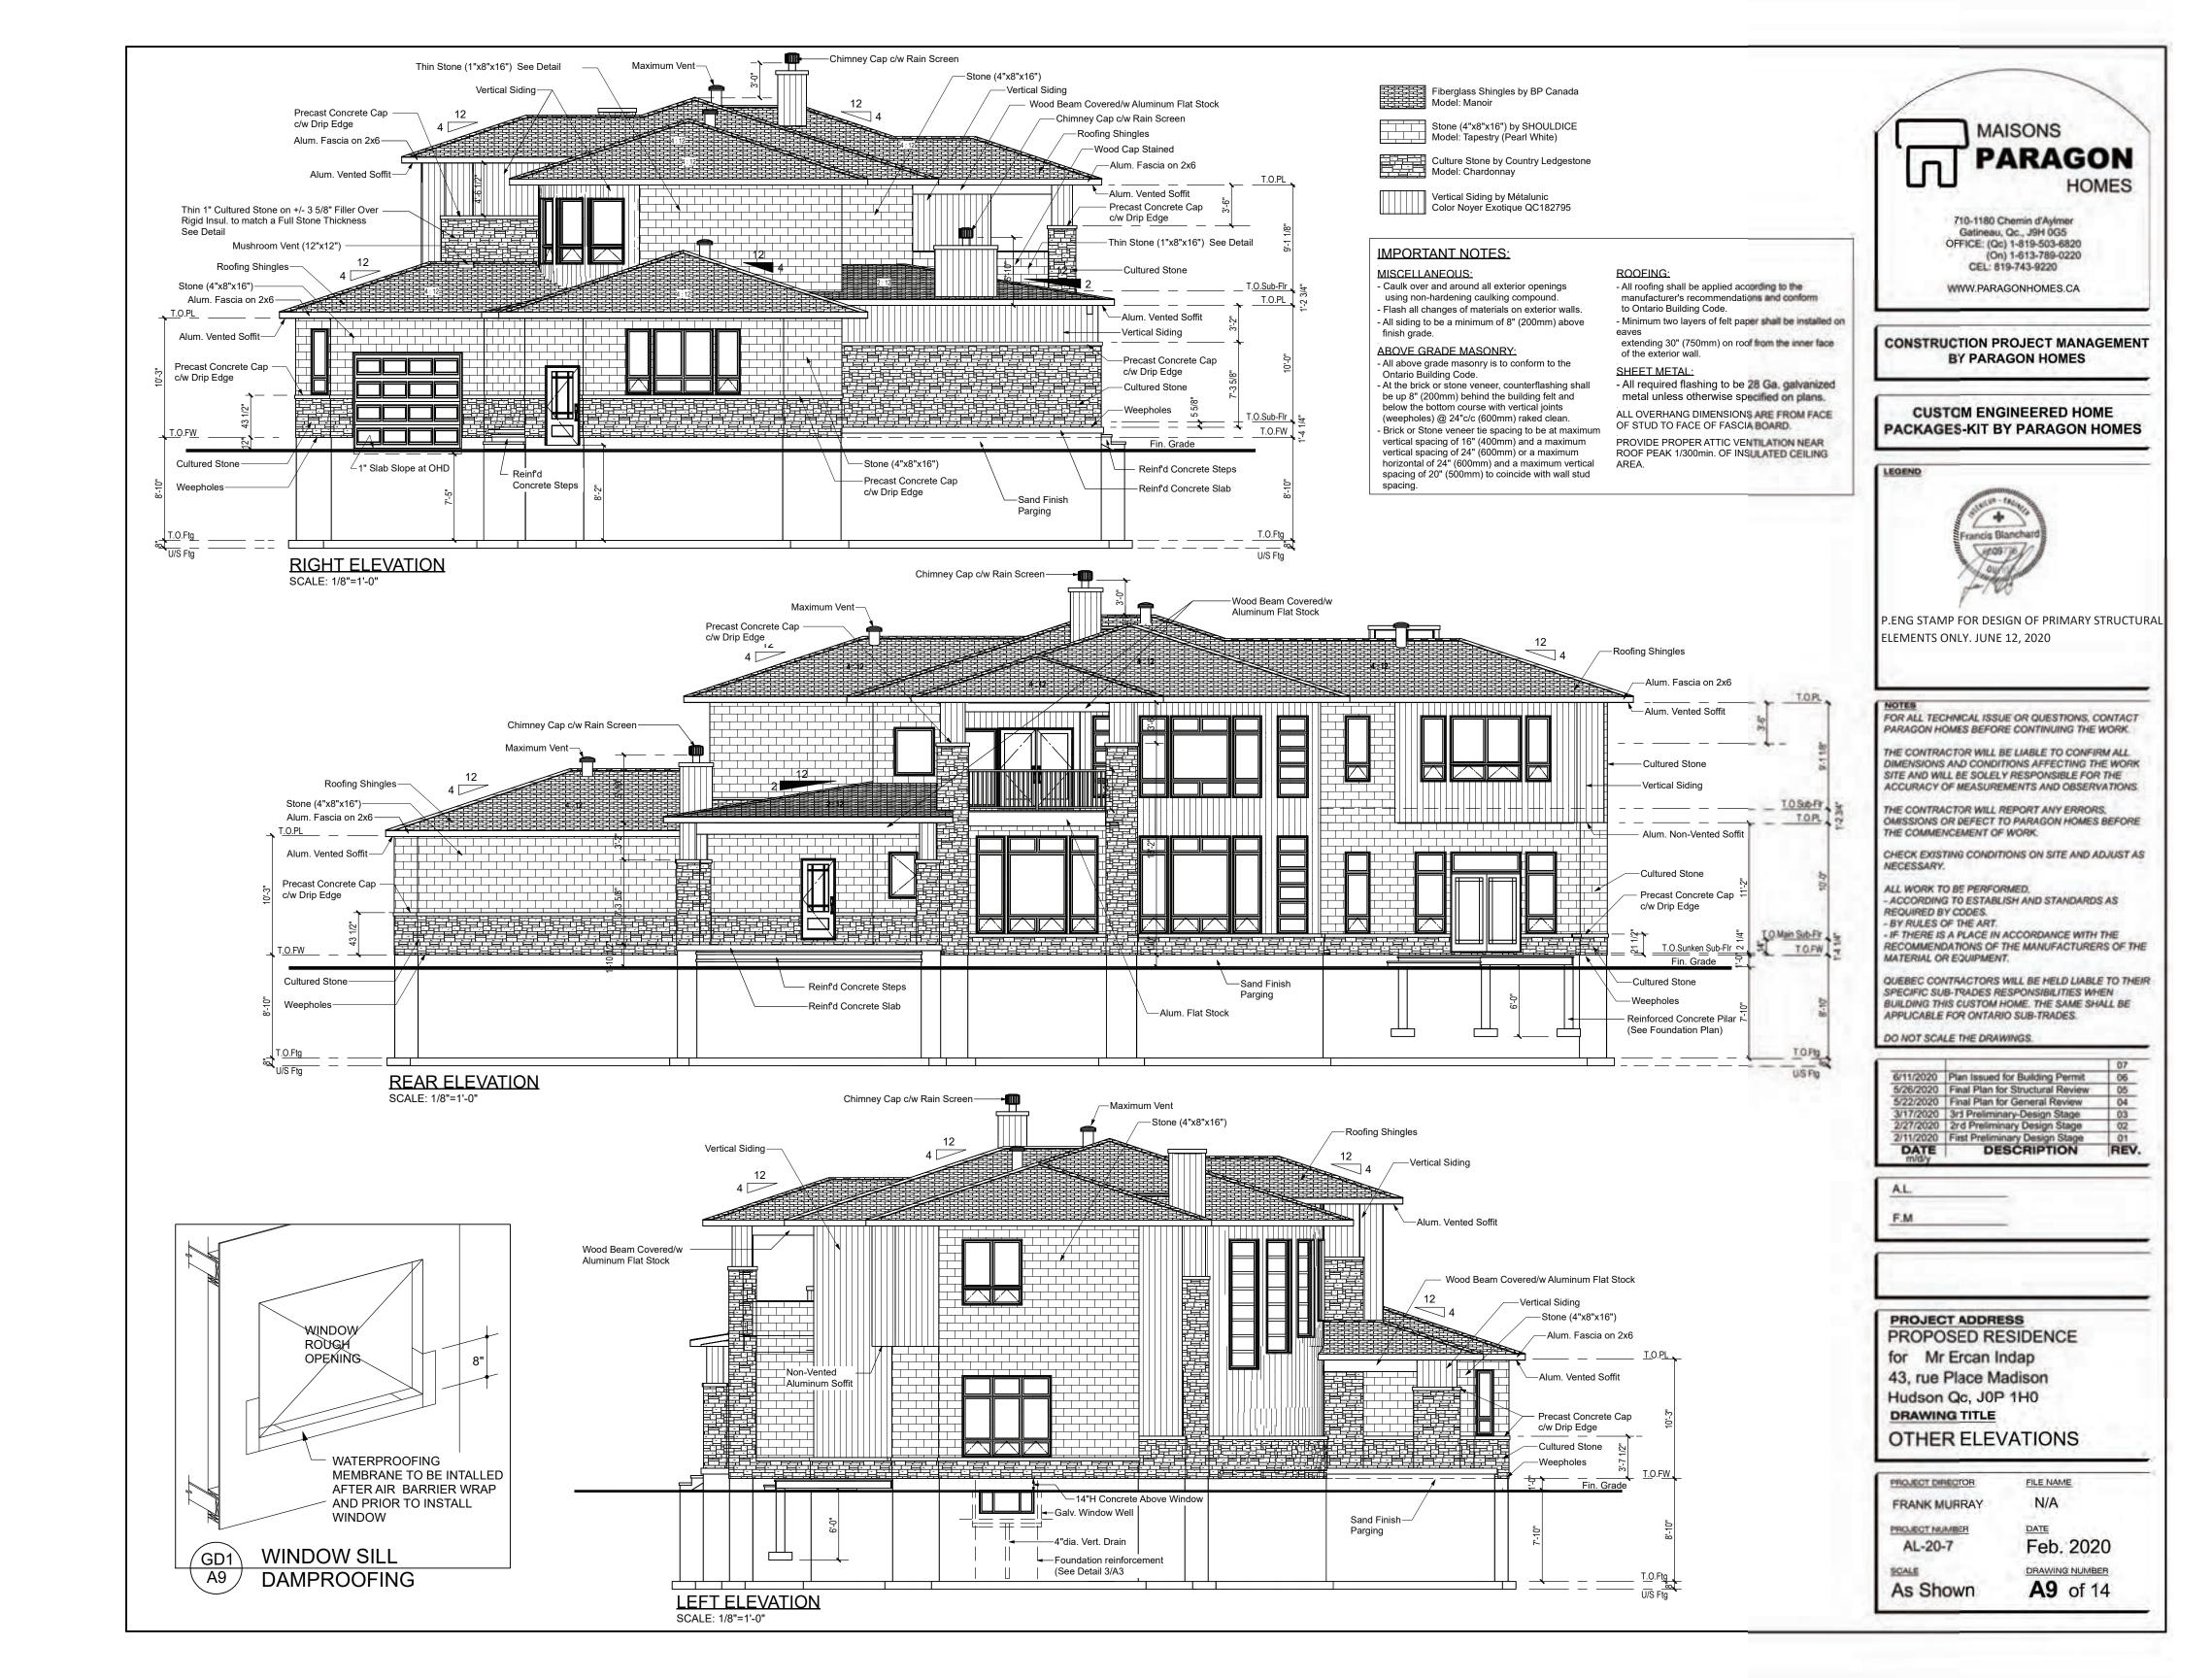

## PARAGON WALL SYSTEM AND KIT COMPONENTS

## **EW-1 EXTERIOR WALL - SIDING**

- VERTICAL SIDING (See Elevation) 1 x 3 HORIZONTAL STRAPPING @ 16"c/c - AIR BARRIER OVERLAPPED MIN. 6" - 1 3/4" ISOCLAD RIGID INSULATION (All Joints
- Sealed and Taped) 7/16" OSB SHEATING
- 2 x 6 K/D WOOD STUDS @ 16"c/c R22 FIBERGLASS BATT INSULATION
- POLY 6 mil VAPOUR BARRIER #CGSB 51.34N (Taped & Sealed Around All Openings) 1 x 3 HORIZONTAL STRAPPING @ 16"c/c 1/2" GYPSUM BOARD (Taped and Painted)

Total Assembly R-Value: R32 Wall Thickness: 10 7/16"

(Color by Owner)

## EW-2 EXTERIOR WALL - STONE

- 4" STONE VENEER (See Elevation)
- 1" AIR SPACE
- AIR BARRIER OVERLAPPED MIN. 6" 1 3/4" ISOCLAD RIGID INSULATION (All Joints Sealed and Taped) 7/16" OSB SHEATING
- 2 x 6 K/D WOOD STUDS @ 16"c/c - R22 FIBERGLASS BATT INSULATION - POLY 6 mil VAPOUR BARRIER #CGSB 51.34M

(Taped & Sealed Around All Openings)

1 x 3 HORIZONTAL STRAPPING @ 16"c/c 1/2" GYPSUM BOARD (Taped and Painted) (Color by Owner)

Total Assembly R-Value: 32 Total Wall Thickness: 13 7/16"

### **EW-3 EXTERIOR WALL -Thin STONE** on 2ND STOREY (SEE DETAIL 1/A9)

- 1" THIN STONE VENEER (See Elevation) TYPE "S" SETTING MORTAR BED
- TYPE "S" SCRATCH MORTAR BED
- METAL LATH - 1 3/4" ISOCLAD RIGID INSULATION (All Joints
- Sealed and Taped) - WATER RESISTANT BARRIERS (2 Layers)
- 7/16" OSB SHEATING - 2 x 6 K/D WOOD STUDS @ 16"c/c
- R22 FIBERGLASS BATT INSULATION - POLY 6 mil VAPOUR BARRIER #CGSB 51.34M (Taped & Sealed Around All Openings)
  1 x 3 HORIZONTAL STRAPPING @ 16"c/c
- 1/2" GYPSUM BOARD (Taped and Painted) (Color by Owner)

Total Assembly R-Value: 32 Total Wall Thickness: 10 1/4"

## **EW-3 EXTERIOR FOUNDATION** WALL with FROST WALL

- SAND FINISH (Above Grade) - PLATON MEMBRANE (Below Grade)
- 25 MPa POURED CONCRETE FOUNDATION WALL
- (Refer to Plan for Wall Thicknesses) - 2" (R-10) RIGID INSULATION CODE BOARD
- 1" AIR SPACE TO SQUARE OFF ROOM
- 2 x 4 K/D WOOD STUDS @ 16"c/c R-12 FIBERGLASS INSULATION
- POLY. 6 mil VAPOUR BARRIER #C(3SB 51.34M
- (Taned & Sealed Around All Openings 1/2" GYPSUM BOARD (Taped and Painted)

Total Assembly R-Value: R-22 Wall Thickness/w 8" Conc: 15'

(Color by Owner)

## I-1 INTERIOR PARTITION WALL (TYP.)

- 1/2" GYPSUM BOARD (Taped & Painted)
- (Color by Owner)
   \* 2 x 4 K/D WOOD STUDS @ 16"c/c
- 1/2" GYPSUM BOARD (Taped & Painted) (Color by Owner)
- ALL INTERIOR PARTITIONS TO BE FRAMED WITH 2 x 4 UNLESS OTHERWISE NOTED ON PLAN \* Strapping to be added when Interior Parties Transform

to an Exterior Wall or moved by 5/8" for a Flush Finish Wall Thickness/w 2x4: 4 1/2" Wall Thickness/w 2x6: 5 1/2"

# I-2 GARAGE / HOUSE DIVIDING WALL

- 1/2" GYPSUM BOARD (Taped & Painted)
- (Color as per Owner)
   1x3 STRAPPING @ 16"c/c
- 1 3/4" ISOCLAD (All Joints Sealed and Taped)
   2 x 6 K/D WOOD STUDS @ 16"c/c
   R-22 FIBER GLASS BATT INSULATION - POLY. 6 mil VAPOUR BARRIER #CGSB 51 34M
- (Taped & Sealed Around All Openings) - 1/2" GYPSUM BOARD (Taped and Fainted)

Total Assembly R-Value: R32 Wall Thickness: 9 15/16"

(Color as per Owner)

\* LOAD BEARING WALL IF MENTIONED ON PLANS are to be Framed/w 2 x 6 @ 16"c/c SPF No1/No2 Unless Otherwise Noted.

## F-1 FLOOR

- FINISH FLOORING (As per Owner)
- 3/4" T/G OSB EDGE GOLD (Glued & Nailed)
- 14" TJI JOISTS @ 16"c/c (Main Floor)
  - (Refer to Manufacturer's Shop Drawings) 1x3 STRAPPING @ 16"c/c
  - 1/2" GYPSUM BOARD (Taped and Painted)

## (Color as per Owner) F-2 STAIR LANDING

FINISH FLOORING (As per Owner) 3/4" T&G OSB EDGE GOLD (Glued & Nailed)

## 2x8 JOISTS @ 16°c/c

F-3 CONCRETE SLAB (HOUSE)

## FINISH FLOORING (As per Owner)

- 3" CONCRETE SLAB (20 MPa) (Buffed)
- 6 MII POLY, VAPOR BARRIER #CGSB 51.34M
- 2" (R-10) SM BLUE RIGID INSULATION
- 8" of CRUSH RUN STONE - UNDISTURBED NATIVE SOIL

- F-4 CONCRETE SLAB (GARAGE) 4" CONCRETE SLAB of 32 MPa c/w 5 to 8% AIR ENTRAINED, Sloped to Floor Drain
- 6 MII POLY, VAPOR BARRIER #CGSB 51,34M. - R10 (2") RIGID INSULATION - 6" of CRUSH RUN STONE SAND BACKFILLED COMPACTED TO 95% MODIFIED PROCTOR IN BETWEEN EACH
- 12" OF LIFT. - UNDISTURBED NATIVE SOIL

THE PROJECT MANAGER AND FRAMER SHALL BE RESPONSIBLE OF THE EXACT PLACING OF THE WALL IN RELATION WITH THE PLANS AND THE ACTUAL SITE CONDITIONS. ANY OMISSIONS SHALL BE RESOLVED BY GENERAL CONTRACTOR. ALL DIFFERENT MATERIAL JUNCTIONS ARE TO BE PROPERLY SEALED AND FLASHED WITH PROPER CAULKING & FLASHING TO SUIT SITE CONDITIONS.

ALL MATERIAL CAN BE CHANGED WITHOUT BE INSTALLED IN STRICT CONFORMANCE WITH MANUFACTURER'S SPECIFICATIONS.

# R-1 TYPICAL ROOF (MAIN ROOF)

- ASPHALT SHINGLES (SEE ELEVATIONS) FELT PAPER AND/OR ICE & WATER SHIELD

FACE OF STUDS.

- PRE-ENGINEERED ROOF TRUSSES @ 24°c/c R60 (House) FIBERGLASS BATT INSULATION
- (Taped and Sealed)
- 1 x 3 STRAPPING @ 24"c/c 1/2" GYPSUM BOARD (Taped and Painted) (Color as per Owner)

## R-2 AUXILIARY ROOF

- 1/2" PLYWOOD C/W "H" CLIPS
- PRE-ENGINEERED ROOF TRUSSES @ 24°c/c
- NON-VENTED ALUMINUM SOFFIT (Color as per Owner)

## R-3 ROOF ABOVE NOOK (DECK FLOOR)

- R60 CLOSE CELL SPRAY FOAM
- (Taped and Sealed) UNDER JOIST 1x3 STRAPPING @ 24°c/c 1/2" DRYWALL (Taped and Painted)

(Color as per Owner)

NOTICE FOR AN EQUIVALENT PRODUCT WITH THE SAME QUALITY, AND ALL MATERIAL SHALL

- MEMBRANE 36° FROM THE EXTERIOR FINISHED
- 1/2" PLYWOOD C/W "H" CLIPS
- R40 (Garage) FIBERGLASS BATT INSULATION 6 Mil POLY, VAPOUR BARRIER #CGSB 51.34M
- \*\* PROVIDE ACCESS TO ATTIC (INSULATED)


## MAIN ENTRY, COVERED PORCH & COVERED DECK

- ASPHALT SHINGLES (SEE ELEVATIONS) INSTALLED AS PER MANUFACTURER'S SPECIFICATIONS FELT PAPER AND/OR ICE & WATER SHIELD MEMBRANE 36" FROM THE EXTERIOR FINISHED
- FACE OF STUDS.
- 1 x 3 STRAPPING @ 24°c/c

- FLEXTONE WATERPROOF MEMBRANE SYSTEM S OR SYSTEM X (See Detail on A2)
- 3/4" T&G PLYWOOD 2x10 JOIST @ 16°c/c AT LEVEL with 2x6 NAILED TO THE SIDE TO PROVIDE 1" SLOPE
- 6 Mil POLY, VAPOUR BARRIER #CGSB 51.34M



Superior than Building Code, EnergySTAR & Novoclimat!

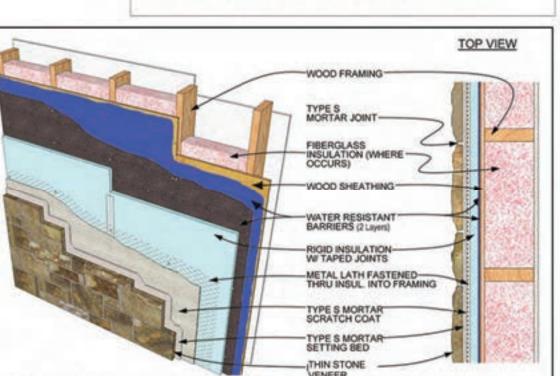

Total R-Value of Wall: R-32

VENEER 1 DETAIL OF THIN STONE VENEER ON 2nd A9 STOREY WALL NOT TO SCALE



CONSTRUCTION PROJECT MANAGEMENT BY PARAGON HOMES

## **CUSTOM ENGINEERED HOME PACKAGES-KIT BY PARAGON HOMES**

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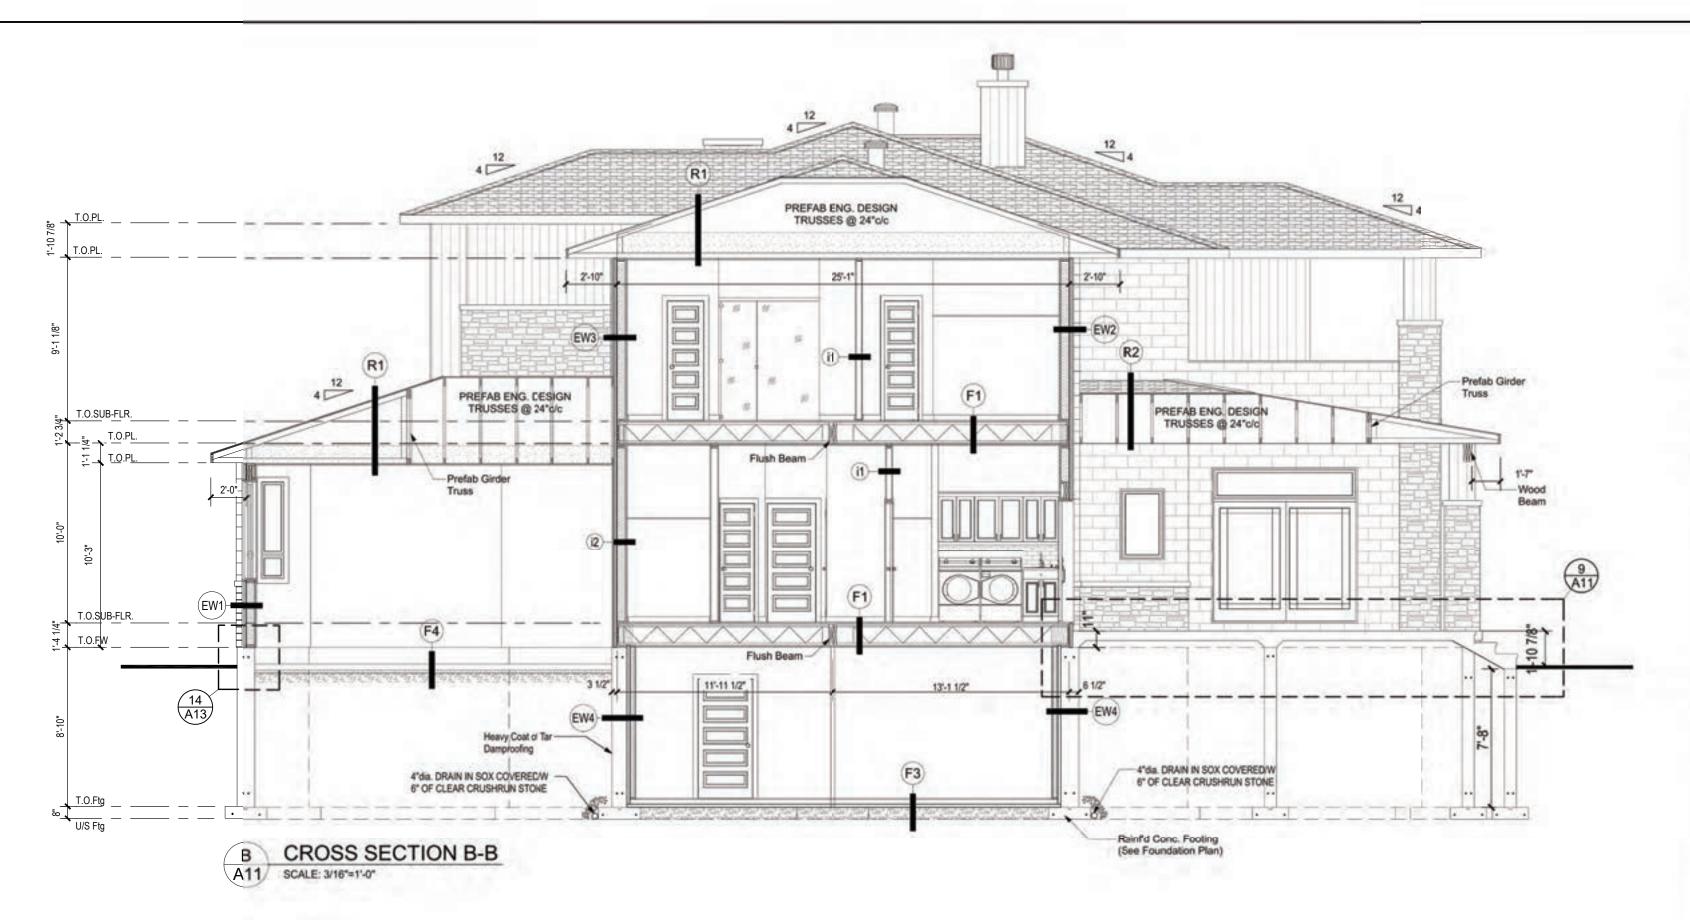
DATE	DESCRIPTION	DEV
2/11/2020	First Preliminary Design Stage	01
	2nd Preliminary Design Stage	02
	3rd Preliminary-Design Stage	03
	Final Plan for General Review	04
ACTION AND ADDRESS OF THE PARTY	Final Plan for Structural Review	05
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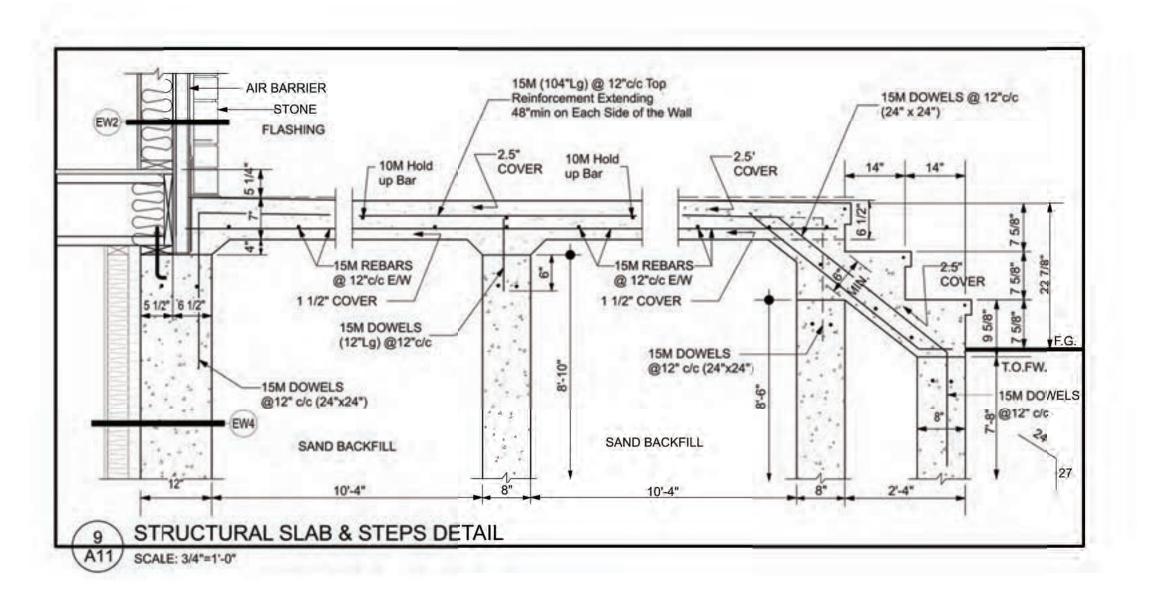
AL. F.M

PROJECT ADDRESS PROPOSED RESIDENCE for Mr Ercan Indap 43, rue Place Madison Hudson Qc, J0P 1H0 DRAWING TITLE

CROSS SECTION A-A

PROJECT DIRECTOR FILE NAME N/A FRANK MURRAY DATE PROJECT NUMBER Feb. 2020 AL-20-7 DRAWING NUMBER SCALE A10 of 14 As Shown







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F.M

PROJECT ADDRESS
PROPOSED RESIDENCE
for Mr Ercan Indap
43, rue Place Madison
Hudson Qc, J0P 1H0
DRAWING TITLE
CROSS SECTION B-B

FRANK MURRAY


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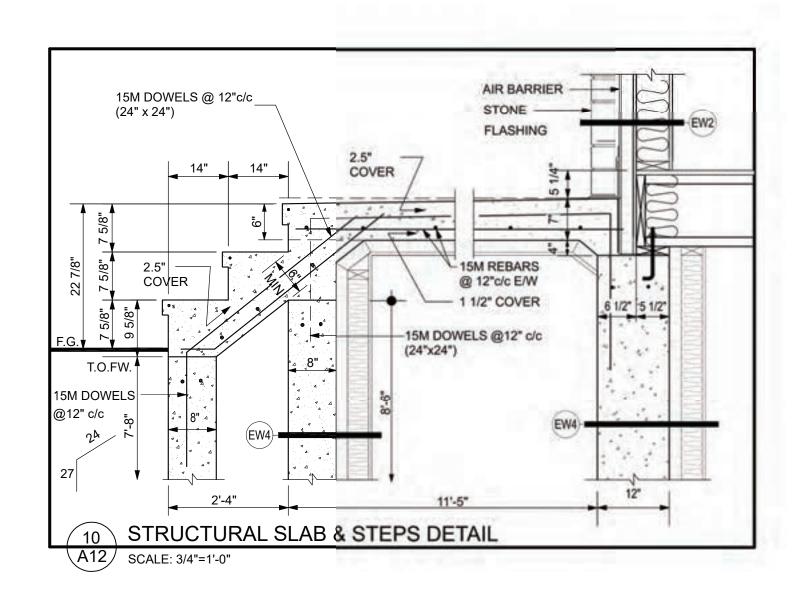
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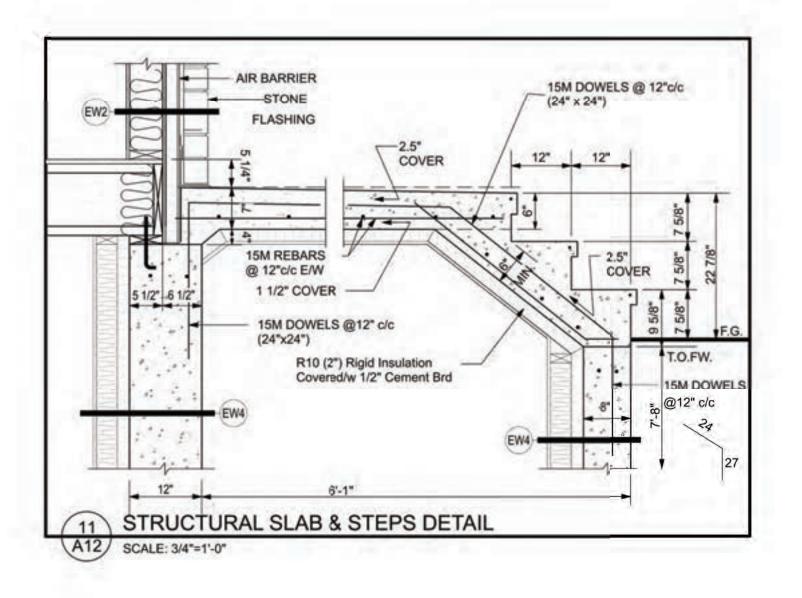
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**A11** of 14

DRAWING NUMBER







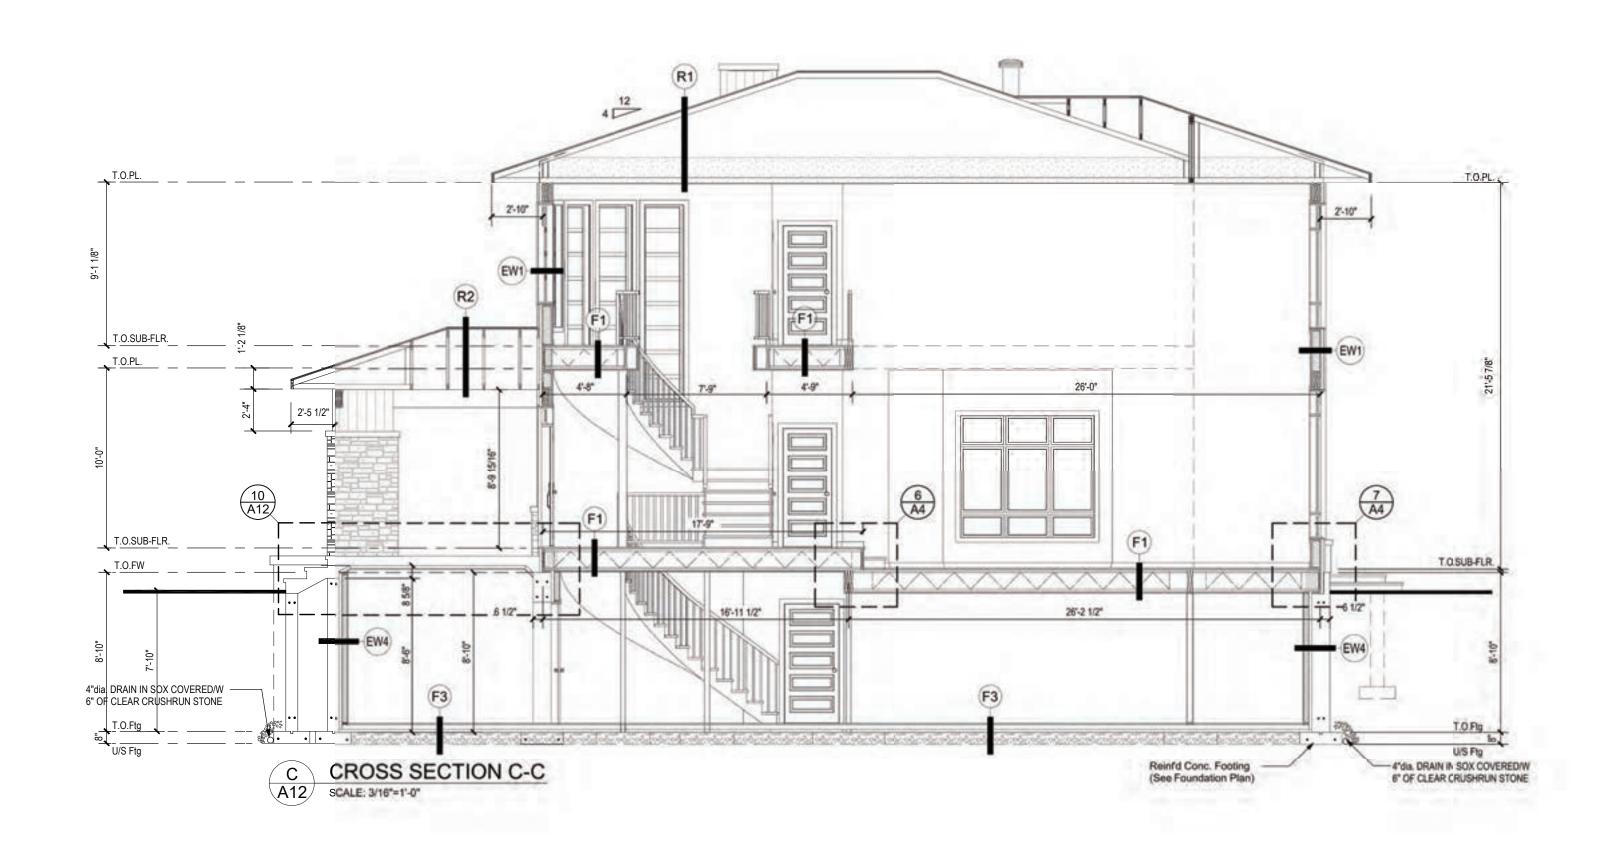

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PROJECT ADDRESS
PROPOSED RESIDENCE
for Mr Ercan Indap
43, rue Place Madison
Hudson Qc, J0P 1H0
DRAWING TITLE
CROSS SECTION C-C

FRANK MURRAY

FRANK MURRAY

PROJECT DIRECTOR

N/A

PROJECT NUMBER

AL-20-7

SCALE

AS Shown


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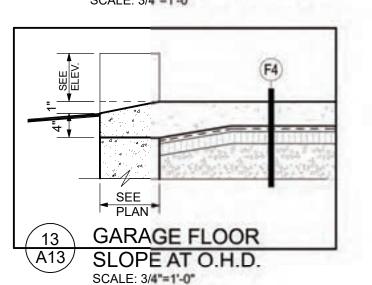
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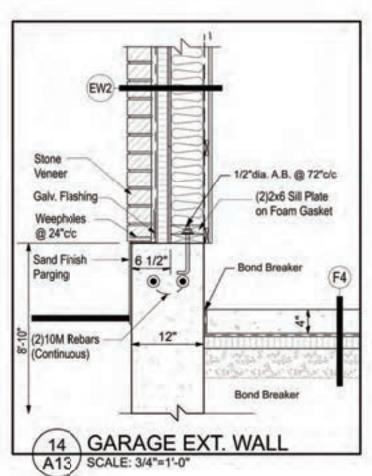
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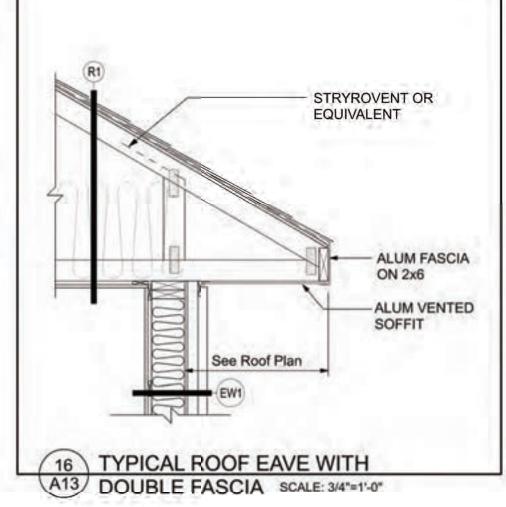
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CONSTRUCTION PROJECT MANAGEMENT BY PARAGON HOMES

**CUSTOM ENGINEERED HOME** PACKAGES-KIT BY PARAGON HOMES

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A.L. F.M

**PROJECT ADDRESS** PROPOSED RESIDENCE for Mr Ercan Indap 43, rue Place Madison Hudson Qc, J0P 1H0 **DRAWING TITLE** 

CONSTRUCTION DETAILS

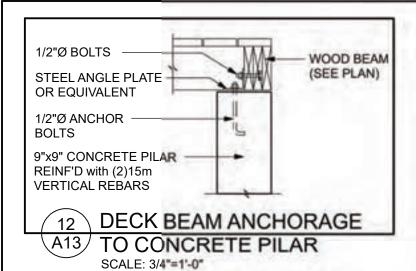PROJECT DIRECTOR FRANK MURRAY PROJECT NUMBER


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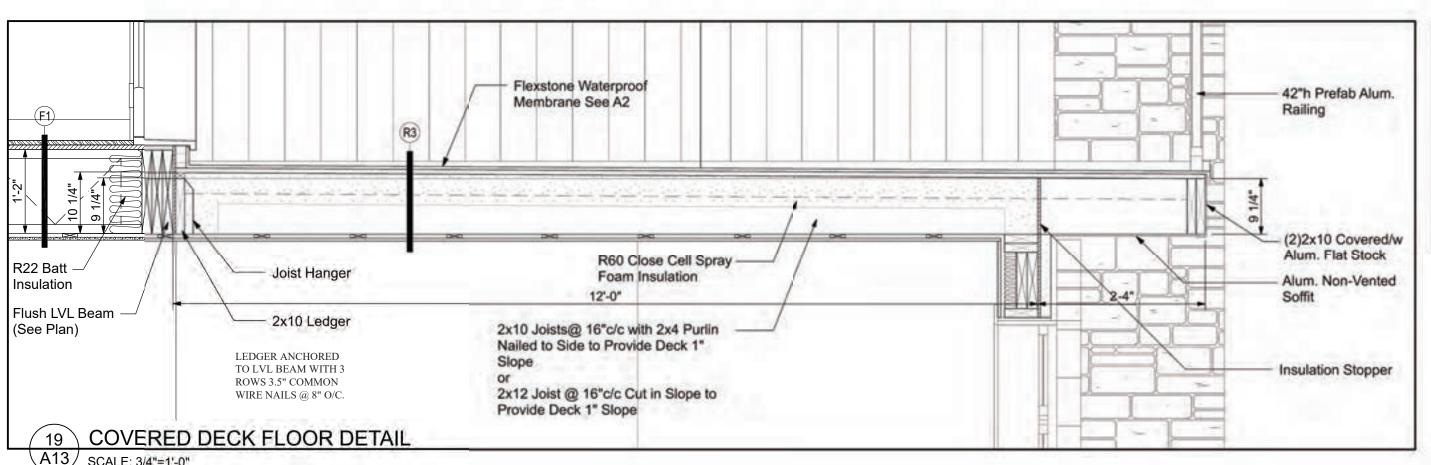
Feb. 2020


AL-20-7


DRAWING NUMBER A13 of 14 As Shown

R40 Batt Insulation (F1) -1 3/4" Rigid Insulation Continuous 5 Wood Support 2x4@16"c/c Wood Beam (See Plan) Bearing on Garage Wall Alum. Non Vented Soffit FLOOR DETAIL 17 A13/ SCALE: 3/4"=1"-0"



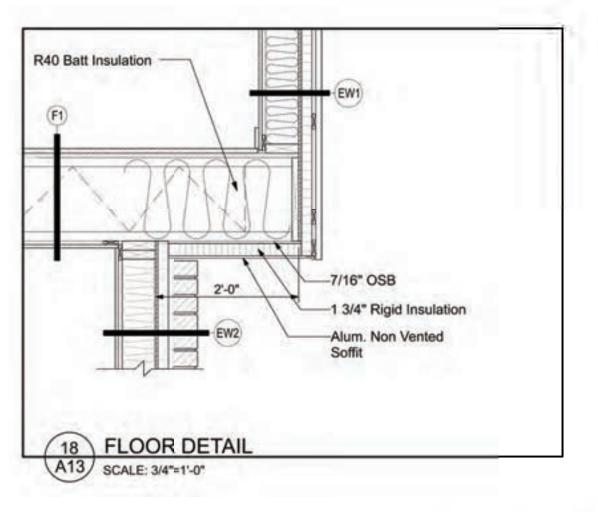

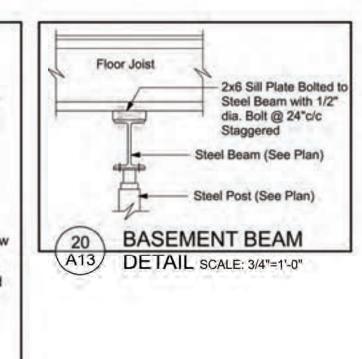

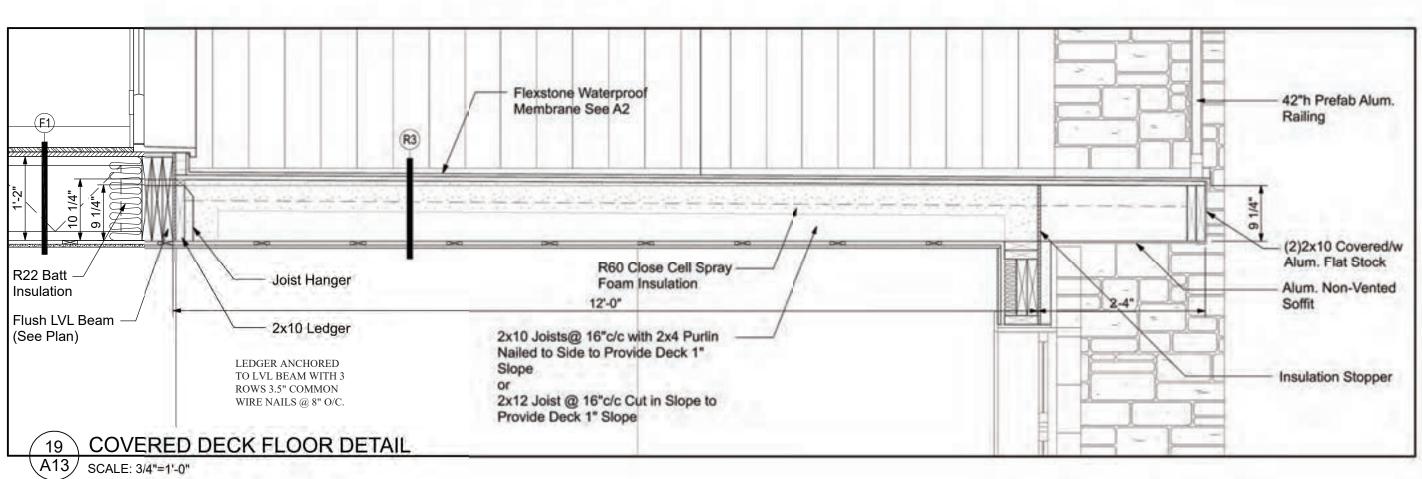

















710-1180 Chemin d'Aylmer Gatineau, Qc., J9H 0G5 OFFICE: (Qc) 1-819-503-6820 (On) 1-613-789-0220 CEL: 819-743-9220

WWW.PARAGONHOMES.CA

CONSTRUCTION PROJECT MANAGEMENT BY PARAGON HOMES

**CUSTOM ENGINEERED HOME** PACKAGES-KIT BY PARAGON HOMES

LEGEND

FOR ALL TECHNICAL ISSUE OR QUESTIONS, CONTACT PARAGON HOMES BEFORE CONTINUING THE WORK

THE CONTRACTOR WILL BE LIABLE TO CONFIRM ALL DIMENSIONS AND CONDITIONS AFFECTING THE WORK SITE AND WILL BE SOLELY RESPONSIBLE FOR THE ACCURACY OF MEASUREMENTS AND OBSERVATIONS.

THE CONTRACTOR WILL REPORT ANY ERRORS, OMISSIONS OR DEFECT TO PARAGON HOMES BEFORE THE COMMENCEMENT OF WORK.

CHECK EXISTING CONDITIONS ON SITE AND ADJUST AS

ALL WORK TO BE PERFORMED.

- ACCORDING TO ESTABLISH AND STANDARDS AS REQUIRED BY CODES.

- BY RULES OF THE ART.

- IF THERE IS A PLACE IN ACCORDANCE WITH THE RECOMMENDATIONS OF THE MANUFACTURERS OF THE MATERIAL OR EQUIPMENT.

QUEBEC CONTRACTORS WILL BE HELD LIABLE TO THEIR SPECIFIC SUB-TRADES RESPONSIBILITIES WHEN BUILDING THIS CUSTOM HOME, THE SAME SHALL BE APPLICABLE FOR ONTARIO SUB-TRADES.

DO NOT SCALE THE DRAWINGS.

DATE	DESCRIPTION	REV.
	First Preliminary Design Stage	01
	2nd Preliminary Design Stage	02
	3rd Preliminary-Design Stage	03
	Final Plan for General Review	04
	Final Plan for Structural Review	05
	Plan Issued for Building Permit	06
	HER STREET, ST	07

PROJECT ADDRESS PROPOSED RESIDENCE for Mr Ercan Indap 43, rue Place Madison Hudson Qc, J0P 1H0 DRAWING TITLE

INTERIOR 3D VIEWS

PROJECT DIRECTOR FILE NAME N/A FRANK MURRAY

PROJECT NUMBER AL-20-7

As Shown

Feb. 2020 DRAWING NUMBER

A14 of 14

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